Engineering ■ Planning ■ Environmental ■ Construction

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# Memorandum

To: Grant Planning Commission Meeting November 19, 2012

Grant City Council Meeting December 4, 2012

From: Breanne Rothstein, City Planner

WSB & Associates

Date: November 9, 2012

Re: Application from Signal Acquisition, LLC for a Conditional Use Permit (CUP) to

Modify and Upgrade Antennas and Associated Equipment on an Existing Cell

Tower-WSB Project # 1936-26

# **Request:**

On September 4, 2012, the City received an application from Signal Acquisition, LLC for a conditional use permit to allow for modifications and upgrades of Sprint's antennas and cabinets on the existing cell tower.

# **Site Characteristics:**

The subject property is located at 11900 Manning Trail. The site is characterized as a small farmstead. There are several other buildings on the site including a home, five other detached buildings, and four silos. The site itself is owned by Craig and Marcia DeWolf and American Tower Corporation owns the tower. The site is surrounded by farm land to the east and west and low density housing to the north and south.

# **Overview:**

Sprint was originally granted approval to install their antennas and cabinets at the existing tower site in 2000. In 2006, Sprint received an amendment to their conditional use permit for modifications and upgrades to their equipment at the site. Documentation of the previously issued CUP and amendment could not be found for review. Therefore, staff proposes issuance of a new conditional use permit for the proposed modifications.

As shown on the submitted plans, Sprint currently has a total of three antenna sectors, with three antennas per sector for a total of nine antennas. As part of this project, Sprint proposes to add an additional 3 antennas (1 per sector) for a total of 12 antennas. The new antenna configuration will be tested by Sprint for a period of approximately 6-12 months. Following this test period, Sprint will remove three old antennas (one per sector), at which point Sprint will return to having a total of 9 antennas.

Other equipment to be added to the tower includes:

• 6 RRHs (Remote Radio Heads)

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- 3 Filters
- 3 Hybrid Fiber Cables
- 1 Micro-Wave dish with 1 ODU and 1 LMR400 cable

All equipment associated with the antennas to be removed will also be removed including cables and RRH units. The micro-wave dish is something new and will be permanent.

On the ground, Sprint will also add two equipment cabinets within their self-contained shelter inside their leased area. These will be permanent and are not replacing cabinets to be removed. The new cabinets will be located entirely within the enclosed shelter inside Sprints leased area. A GPS antenna will also be added on the ground, most likely on a protective cover used for their coaxial cable coming out of the shelter at the base of the tower. The GPS antenna will be no taller than 15 feet off the ground.

In the review of the application, the property owner had not signed the application, and staff has requested that information.

# **Grant City Code Requirements:**

Section 32-446, (a) of the Grant City Code states that a conditional use permit is required before any antenna or antenna support structure is installed or constructed for all cases that do not qualify for an administrative permit. While no individual upgrade requires a conditional use permit amendment, staff interpreted the total of all proposed changes (temporary antenna upgrades, the addition of a satellite dish, addition of cables, filters, new cabinets, and other appurtenances) to require a conditional use permit.

City code specifies standards for approving all conditional use permits, which are listed below:

- The use conforms with the City's Comprehensive Plan
- The use will not be detrimental to or endanger the public health, safety or general welfare of the city, its residents, or the existing neighborhood
- The use is compatible with the existing neighborhood
- The use meets condition or standards adopted by the city through other ordinances
- The use will not create additional requirements for facilities and services at public cost beyond normal uses
- The use will not involve use or activities that will be detrimental to people, property, or the general welfare because of production of traffic, noise, smoke, fumes, glare, odors or any other nuisances
- The use will not result in the destruction, loss or damage of natural, scenic, or historic features of importance
- The use will not increase flood potential or create additional water runoff onto surrounding properties

# **Analysis:**

As technology improves, staff recognizes that such modifications are necessary to provide improved telecommunications service within the City of Grant. The use of antennas on the site is a permitted use and is consistent with the comprehensive plan. There are no elements of the proposal that will be detrimental to or endanger the public health, safety or general welfare of the

CUP Application November 9, 2012 Page 3

city, its residents, or the existing neighborhood. The use is compatible with the existing neighborhood. The use meets all conditions and standards adopted by the city. The use and proposed modifications by Sprint will not create additional requirements for facilities and services at public cost beyond normal uses. The use will not involve activities that will be detrimental to people, property, or the general welfare and will not produce any traffic, noise, smoke, fumes, glare, odors or any other nuisances. The use will not result in the destruction, loss or damage of natural, scenic, or historic features of importance. Also, the use will not increase flood potential or create additional water runoff onto surrounding properties.

# **Recommendation:**

The proposed modifications by Sprint are consistent with all provisions of the code and all standards for approving conditional use permits.

Staff recommends approval of the requested conditional use permit, subject to the following conditions:

- 1) Consent by property owner in the form of a signed application or letter stating such;
- 2) Payment of all land use fees associated with the application.

# **Requested Motion:**

Motion recommend that the City Council approve the application for a conditional use permit to allow for the addition of equipment to the tower located at 11900 Manning Trail, subject to the conditions, and direct staff to prepare a resolution declaring terms of the same.

# **Attachments**

- 1) Location Map
- 2) Application Materials

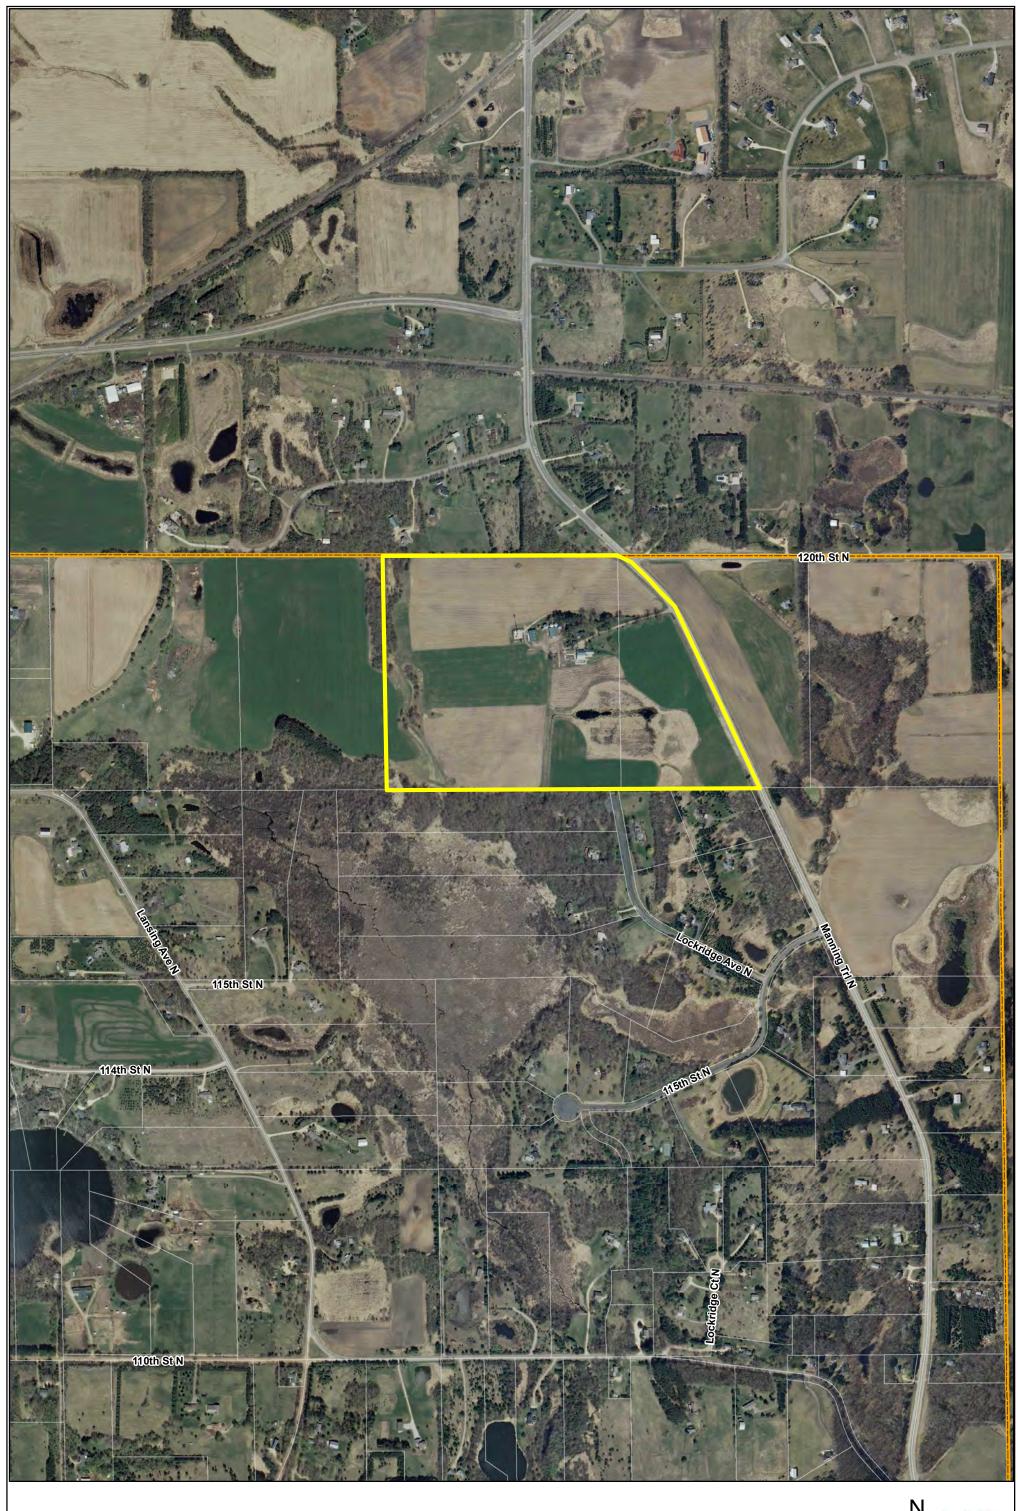


Exhibit A

Location Map 11900 Manning Trail



City of Grant P.O. Box 577 Willemie, MN 55090



Phone: 651.426.3383 Fax: 651.429.1998 Email: clerk@cityofgrant.com

Application Date:	
Fee: \$400	Escrow: \$3,000

# **CONDITIONAL USE PERMIT**

Certain uses, while generally not suitable in a particular Zoning District, may, under certain circumstances be acceptable. When such circumstances exist, a Conditional Use Permit may be granted. Conditions may be applied to the issuance of the Permit and/or periodic review may be required. The Permit shall be granted for a particular use and not for a particular person or firm.

PARCEL IDENTIFICATION NO (PIN	1: 0103021210001	ZONING DISTRICT & COMP PLAN LAND	USE:
LEGAL DESCRIPTION:	-	A-1, AG, La	rue
GECOL, TWP	030, RNG 021	LOT SIZE: A-1, AG, La	cale
PROJECT ADDRESS:	OWNER: ( Tower only )	APPLICANT (IF DIFFERENT THAN OWN	ER):
11900 Manningtol	Name: (Tower only) Name: A merican Tower Corp	SIGNAL ACO., LLC	
	Address: 1101 Schaumburg, IL	% JOHN KNAPEK	
Gran+, MN 55082	City, State:		me
37-02	Phone:	18285 Imagery La Lakeville, and 55	ากนน
	Email:	612.986.1993	<b>V</b>   1
BRIEF DESCRIPTION OF REQUES ANTENNAS & CABIN	T: MODIFICATION/UPG JETS ON THIS EXISTIN	RADE OF SPIRMT TELL G CELL TOWER.	<i>Ecom</i>
EXISTING SITE CONDITIONS:			
APPLICABLE ZONING CODE SEC	TION(S):		
Please review the referenced code s	ection for a detailed description of required	l submittal documents, and subsequent proc	ess.
Division 5. Conditional Use	Permits 32-141 through 157		

# **Submittal Materials**

The following materials must be submitted with your application in order to be considered complete. If you have any questions or concerns regarding the necessary materials please contact the City Planner.

AP - Applicant check list, CS - City Staff check list

AP	cs	MATERIALS
		Site Plan: All full scale plans shall be at a scale not smaller than 1" = 100' and include a north arrow
		<ul> <li>Property dimensions</li> <li>Area in acres and square feet</li> <li>Setbacks</li> <li>Location of existing and proposed buildings (including footprint, and dimensions to lot lines)</li> <li>Location of utilities</li> <li>Location of well and septic systems on adjacent properties</li> <li>Location of current and proposed curb cuts, driveways and access roads</li> <li>Existing and proposed parking (if applicable)</li> <li>Off-street loading areas (if applicable)</li> <li>Existing and proposed sidewalks and trails</li> <li>Sanitary sewer and water utility plans</li> </ul>
		COPIES: 4 plans at 22"x34", 20 plans at 11"x17"

# Application for: CONDITIONAL USE PERMIT City of Grant

		Grading/Landscape Plan: All full scale plans shall be at a scale not smaller than 1" = 100' and include a north arrow
		<ul> <li>Grading Plan</li> <li>Vegetation, landscaping, and screening plans including species and size of trees and shrubs</li> <li>Wetland Delineation</li> <li>Buildable area</li> <li>Topographic contours at 2-foot intervals, bluff line (if applicable)</li> <li>Waterbodies, Ordinary High Water Level and 100 year flood elevation</li> <li>Finished grading and drainage plan sufficient to drain and dispose of all surface water accumulated</li> </ul>
······		COPIES: 4 plan sets 22"x34", 20 plan sets 11"x17"
		Architectural/Building Plan (if Applicable): All full scale plans shall be at a scale not smaller than 1" = 100' and include a north arrow
		<ul> <li>Location of proposed buildings and their size including dimensions and total square footage</li> <li>Proposed floor plans</li> <li>Proposed elevations</li> <li>Description of building use</li> </ul>
		COPIES: 4 plan sets 22"x34", 20 plan sets 11"x17"
		<ul> <li>Written Narrative Describing your request: A written description of your request for the Conditional Use will be required to be submitted as a part of your application. The description must include the following:</li> <li>Description of operation or use</li> </ul>
		<ul> <li>Number of employees (if applicable, if not state why)</li> </ul>
		<ul> <li>Sewer and water flow/user rates (if applicable, if not state why)</li> <li>Any soil limitations for the intended use, and plan indicating conservation/BMP's</li> </ul>
:		<ul> <li>Hours of operation, including days and times (if applicable)</li> </ul>
		<ul> <li>Describe how you believe the requested conditional use fits the City's comprehensive plan</li> <li>COPIES: 20</li> </ul>
		Statement acknowledging that you have contacted the other governmental agencies such as Watershed Districts, County departments, State agencies, or others that may have authority over your property for approvals and necessary permits.
		Mailing labels with names and address of property owners within ¼ mile (1,320 feet).
U,		Paid Application Fee: \$400
V		Escrow Paid: \$3,000
MATE	RIALS T	HAT MAY BE REQUIRED UPON THE REQUEST OF THE CITY PLANNER
		Survey of the property: An official survey, by a licensed surveyor, must be submitted with the application. The survey shall be scalable and in an 11" x 17" or 8 1/2" x 11" format.
		Electronic copy of all submittal documents
This app	olication	must be signed by ALL owners of the subject property or an explanation given why this not the case.
We, the	un <b>d</b> ersig	gned, have read and understand the above.
08	200	24-2012
Signatur	re of App	Slicant AGENT FOR SPRINT Date
		2 man 1 m At Mul
		ner (if different than applicant)  Date

# Signal Acquisition, LLC

# *Wireless/ Telecom Consultant 18285 Imagery Lane Lakeville, MN 55044*

office: 952,236,8845 mobile: 612,986,1993



September 4, 2012

RE: Memo to the Sprint Zoning Permit File – Letter / Narrative to City of Grant regarding proposed improvements

Re: CUP Amendment for SPRINT tower site situated: 11900 Manning Trail, Grant, MN 55082 PID 0103021210001 — "DeWolf" property / MS72XC330

City of Grant, MN City of Grant Plan review P.O. Box 577, Willernie, MN 55090

City of Grant:

City of Grant, MN.

This narrative serves to demonstrate the necessity for Sprint PCS to request an amendment to their CUP for the above referenced telecom tower site.

Sprint and Nextel (nka: Sprint PCS) was approved back in 2000 and in 2006 to install their antennas and cabinets on this existing tower, owned by American Tower Corporation through the

For this CUP Amendment, Sprint proposes to:

Add (3) antennas more to their current antenna count. One antenna to each of their antenna sector configurations.

Currently, Sprint has 3 antennas per sector, with a TOTAL antenna count of 9. After installing (1) antenna per sector -- Sprint shall have a TOTAL antenna count of 12 antennas affixed on the tower.

For an interim period (6 months) -- Sprint will test their new upgraded system configuration. After 6 months -- Sprint will remove one of their old 'legacy' antennas per sector. The one antenna per sector to be removed will be a "CDMA" (old technology or "legacy") from remaining equipment.

Sprint will then have a final antenna TOTAL of 9 antennas.

Additionally, Sprint plans to add:

- (6) RRHs, {Remote Radio Heads},
- (3) Filters.
- (3) Hybrid Fiber Cables,
- 1 Micro-Wave dish with 1 ODU and 1 LMR400 cable.

Sprint will also add (2) equipment cabinets to its existing configuration within their self-contained shelter inside their leased area.

(1) GPS Antenna will be added on the ground, most likely on a protective cover used for their coaxial cable coming out of their shelter at the base of the tower.

The GPS antenna will be no taller than 15 feet off the ground.

The existing Sprint antennas & associated equipment, will be "REMOVED" after a "TEST PERIOD" of (6) Six Months to (1) One Year.

With these noted changes – the City of Grant has been provided a set of the proposed changes referenced in the "Construction Drawings".

Also provided is a Structural Analysis report -- indicating the tower structure being capable of supporting the increased loading.

Let me know if there are any questions to this narrative.

Respectfully,


John Knapek

Agent for Sprint PCS

Signal Acquisition, LLC

18285 Imagery Lane

Lakeville, MN 55044 jeknapek@yahoo.com

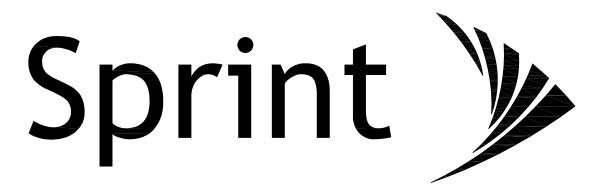

SITE NAME: F1 / MN0330-WITHROP

ATC SITE NAME: DEWOLF

SITE NUMBER: MS72XC330-A

ATC SITE NUMBER: 50336

SITE ADDRESS: 19900 MANNING TRAIL N

STILLWATER, MN. 55082 WASHINGTON COUNTY

SITE TYPE: EXISTING 195' MONOPOLE










$\dashv$	PROJECT NO:	172862
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	CHECKED BY:	SEW
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	REV	DATE	DESCRIPTION
	А	07/23/12	90% ISSUED FOR REVIEW
	В	10/01/12	90% ISSUED FOR PERMITTING
	0	10/03/12	100% ISSUED FOR CONSTRUCTION
	1	10/17/12	100% ISSUED FOR CONSTRUCTION
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PROFESSIONAL ENGINEER
I hereby certify that this plan, specification, or report was prepared by me or under my direct supervision and that I am a duly Licensed Professional Engineer under the laws of the State of Minnesota.

MS72XC330-A F1/MN0330-WITHROP 19900 MANNING TRAIL N STILLWATER, MN 55082

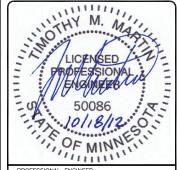SHEET TITLE

TITLE SHEET & PROJECT DATA

SHEET NUMBER

T-1



# SITE ADDRESS: 19900 MANNING TRAIL N STILLWATER, MN 55082

PROPERTY OWNER:
AMERICAN TOWER
10 PRESIDENTIAL WAY
WOBURN, MA 01801

ATC SITE#: 50336

# EQUIPMENT SUPPLIER:

SAMSUNG TELECOMMUNICATIONS AMERICA (STA) 1301 EAST LOOKOUT DRIVE RICHARDSON, TX 75082-4124 (972) 761-7000

# FIBER PROVIDER:

AAV - N/A DONOR - N/A

# POWER COMPANY:

TEL 00 001/041

TELCO COMPANY:
QWEST

COUNTY: WASHINGTON

# ZONING JURISDICTION:

ZONING DISTRICT:

AGRICULTURAL/RESIDENTIAL

### LATITUDE (NAD83): 45° 7' 19.599" N 45.12211111°

LONGITUDE (NAD83): 92° 52' 36.199" W -92.87672222°

# CONTACT ENGINEER:

TIMOTHY M. MARTIN, P.E (512) 320-0988 tmartin@letsvolver.com



AREA MAP APPLICABLE CODES DRAWING INDEX ALL WORK SHALL COMPLY WITH THE FOLLOWING APPLICABLE CODES: SHEET NO: SHEET TITLE IBC 2006 (2007 MINNESOTA STATE BUILDING CODE) TITLE SHEET & PROJECT DATA 2009 MINNESOTA PLUMBING CODE GN-1 GENERAL NOTES 1 NEC 2008 ELECTRICAL CODE GN-2 GENERAL NOTES 2 A-1 OVERALL SITE PLAN IN THE EVENT OF CONFLICT, THE MOST RESTRICTIVE CODE SHALL A-2 EQUIPMENT LAYOUTS TOWER ELEVATION & COAX DETAILS A-3 PROJECT DESCRIPTION ANTENNA/MICROWAVE SCHEDULES & LAYOUT A-4 . REMOVE EXISTING CABINETS AND ANTENNAS A-5 EQUIPMENT DETAILS A-6 EQUIPMENT DETAILS INSTALL (1) MMBS-BBU CABINET IN EXISTING LEASE SPACE A-7 FOUIPMENT DETAILS EQUIPMENT DETAILS • INSTALL (1) MMBS-BATTERY CABINET IN EXISTING LEASE SPACE A-9 FOUIPMENT DETAILS • INSTALL (3) PANEL ANTENNAS RF-1 ANTENNA & CABLE COLOR CODING DETAILS RF-2 ANTENNA/RRU JUMPER SCHEMATIC • INSTALL (3) RRU'S TO TOWER E-1 SINGLE LINE DIAGRAM & POWER PANEL SCHEDU INSTALL (18) JUMPERS DC POWER ONE-LINE & DETAILS F-3 POWER & TELCO DETAILS . INSTALL (1) GROUND MOUNTED GPS ANTENNA E-4 POST-MIGRATION PANEL SCHEDULE • INSTALL (1) MICROWAVE DISH GROUNDING PLAN & NOTES G-1 INSTALL (3) HYBRID CABLES G-3 GROUNDING DETAILS G-4GROUNDING DETAILS LOCATION MAP S-2 STRUCTURAL DETAILS 124th St N 122nd St N ENGINEER OF RECORD TIMOTHY M. MARTIN, P.E. PE #50086 IRISH TOWER, LLC

# DRIVING DIRECTIONS FROM NEAREST MAJOR AIRPORT

DEPART MINNEAPOLIS ST. PAUL INTERNATIONAL AIRPORT. START OUT GOING NORTHWEST ON GLUMACK DR, TURN SLIGHT LEFT TOWARD PARKING. STAY STRAIGHT TO GO ONTO GLUMACK DR. MERGE ONTO MN-5E TOWARD MN-55/ST PAUL/MINNEAPOLIS. TAKE THE MN-55W/MN-55E EXIT TWARD MINNEAPOLIS/FORT SNELLING/HASTINGS. MERGE ONTO MN-55E TOWARD MENDOATA BE. TAKE MN-110E TOWARD MN-13N. TAKE THE I-494E/US-52 RAMP. MERGE ONTO I-494E VIA THE RAMP ON THE LEFT. MERGE ONTO I-694N. MERGE ONTO MN-36E VIA EXIT 52B TOWARD STILLWATER. TURN LEFT ONTO MANNING AVE N. MANNING AVE N. BECOMES MANNING TRAIL N. ARRIVE AT SITE.

# GENERAL CONSTRUCTION NOTES

- ALL WORK SHALL CONFORM TO THE REQUIREMENTS OF THE LOCAL BUILDING CODE, THE LATEST EDITION AND ALL OTHER APPLICABLE CODES AND ORDINANCES.
- CONTRACTOR SHALL CONSTRUCT SITE IN ACCORDANCE WITH THESE DRAWINGS AND SPRINT INTEGRATED CONSTRUCTION STANDARDS FOR WIRELESS SITES (LATEST REVISION). THE SPECIFICATION IS THE RULING DOCUMENT AND ANY DISCREPANCIES BETWEEN THE SPECIFICATION AD THESE DRAWINGS SHOULD BE BROUGHT TO THE ATTENTION OF THE ENGINEER PRIOR TO PROCEEDING WITH
- CONTRACTOR SHALL VISIT THE JOB SITE AND SHALL FAMILIARIZE HIMSELF WITH ALL CONDITIONS AFFECTING THE PROPOSED WORK AND SHALL MAKE PROVISIONS AS TO THE COST THEREOF. CONTRACTOR SHALL BE RESPONSIBLE FOR FAMILIARIZING HIMSELF WITH ALL CONTRACT DOCUMENTS, FIELD CONDITIONS AND DIMENSIONS AND CONFIRMING THAT THE WORK MAY BE ACCOMPLISHED AS SHOWN PRIOR TO PROCEEDING WITH CONSTRUCTION. ANY DISCREPANCIES SHALL BE BROUGHT TO THE ATTENTION OF THE ENGINEER PRIOR TO THE COMMENCEMENT OF WORK. NO COMPENSATION WILL BE AWARDED BASED ON CLAIM OF LACK OF KNOWLEDGE OF FIELD CONDITIONS.
- PLANS ARE NOT TO BE SCALED. THESE PLANS ARE INTENDED TO BE A DIAGRAMMATIC OUTLINE ONLY UNLESS OTHERWISE NOTED. THE WORK SHALL INCLUDE FURNISHING MATERIALS, EQUIPMENT AND APPURTENANCES, AND LABOR NECESSARY TO EFFECT ALL INSTALLATIONS AS INDICATED ON THE
- DIMENSIONS SHOWN ARE TO FINISH SURFACES UNLESS OTHERWISE NOTED. SPACING BETWEEN EQUIPMENT IS REQUIRED CLEARANCE. THEREFORE, IT IS CRITICAL TO FIELD VERIFY DIMENSIONS, SHOULD THERE BE ANY QUESTIONS REGARDING THE CONTRACT DOCUMENTS, EXISTING CONDITIONS AND/OR DESIGN INTENT, THE CONTRACTOR SHALL BE RESPONSIBLE FOR OBTAINING A CLARIFICATION FROM AUTHORIZED REPRESENTATIVE OF THE ENGINEER PRIOR TO PROCEEDING WITH THE WORK
- DETAILS ARE INTENDED TO SHOW DESIGN INTENT. MODIFICATIONS MAY BE REQUIRED TO SUIT JOE DIMENSIONS OR CONDITIONS, AND SUCH MODIFICATIONS SHALL BE INCLUDED AS PART OF THE WORK.
- CONTRACTOR SHALL RECEIVE CLARIFICATION IN WRITING, AND SHALL RECEIVE IN WRITING AUTHORIZATION TO PROCEED BEFORE STARTING WORK ON ANY ITEMS NOT CLEARLY DEFINED OR IDENTIFIED BY THE CONTRACT DOCUMENTS.
- CONTRACTOR SHALL SUPERVISE AND DIRECT THE WORK USING THE BEST CONSTRUCTION SKILLS AND ATTENTION. CONTRACTOR SHALL BE SOLELY RESPONSIBLE FOR CONSTRUCTION MEANS, METHODS, TECHNIQUES, SEQUENCES AND PROCEDURES AND FOR COORDINATING ALL PORTIONS OF THE WORK UNDER CONTRACT, UNLESS OTHERWISE NOTED.
- CONTRACTOR SHALL BE RESPONSIBLE FOR THE SAFETY OF THE WORK AREA. ADJACENT AREAS AND BUILDING OCCUPANTS THAT ARE LIKELY TO BE AFFECTED BY THE WORK UNDER THIS CONTRACT. WORK SHALL CONFORM TO ALL OSHA REQUIREMENTS.
- 10. CONTRACTOR SHALL COORDINATE HIS WORK WITH THE SUPERINTENDENT OF BUILDINGS & GROUNDS AND SCHEDULE HIS ACTIVITIES AND WORKING HOURS IN ACCORDANCE WITH THE REQUIREMENTS
- 11. CONTRACTOR SHALL BE RESPONSIBLE FOR COORDINATING HIS WORK WITH THE WORK OF OTHERS AS IT MAY RELATE TO RADIO EQUIPMENT, ANTENNAS AND ANY OTHER PORTIONS OF THE WORK.
- 12. INSTALL ALL EQUIPMENT AND MATERIALS IN ACCORDANCE WITH MANUFACTURERS RECOMMENDATIONS UNLESS SPECIFICALLY OTHERWISE INDICATED OR WHERE LOCAL CODES OR REGULATIONS TAKE PRECEDENCE.
- 13. MAKE NECESSARY PROVISIONS TO PROTECT EXISTING SURFACES, EQUIPMENT, IMPROVEMENTS, PIPING ETC. AND IMMEDIATELY REPAIR ANY DAMAGE THAT OCCURS DURING CONSTRUCTION.
- DRILLING HOLES INTO CONCRETE WHETHER FOR FASTENING OR ANCHORING PURPOSES, PENETRATIONS THROUGH THE FLOOR FOR CONDUIT RUNS, PIPE RUNS, ETC., MUST BE CLEARLY UNDERSTOOD THAT REINFORCING STEEL SHALL NOT BE DRILLED INTO, CUT OR DAMAGED UNDER ANY CIRCUMSTANCES (UNLESS NOTED OTHERWISE). LOCATIONS OF REINFORCING STEEL ARE NOT DEFINITELY KNOWN AND THEREFORE MUST BE SEARCHED FOR BY APPROPRIATE METHODS AND FOLIPMENT
- 15. REPAIR ALL EXISTING WALL SURFACES DAMAGED DURING CONSTRUCTION SUCH THAT THEY MATCH AND BLEND IN WITH ADJACENT SURFACES.
- 16. SEAL PENETRATIONS THROUGH FIRE RATED AREAS WITH U.L. LISTED AND FIRE CODE APPROVED
- 17. KEEP CONTRACT AREA CLEAN, HAZARD FREE, AND DISPOSE OF ALL DIRT, DEBRIS, AND RUBBISH. EQUIPMENT NOT SPECIFIED AS REMAINING ON THE PROPERTY OF THE OWNER SHALL BE REMOVED. LEAVE PREMISES IN CLEAN CONDITION AND FREE FROM PAINT SPOTS, DUST, OR SMUDGES OF ANY NATURE. CONTRACTOR SHALL BE RESPONSIBLE FOR MAINTAINING ALL ITEMS UNTIL COMPLETION OF
- 18. MINIMUM BEND RADIUS OF ANTENNA CABLES SHALL BE IN ACCORDANCE WITH CABLE MANUFACTURERS
- 19. ALL EXISTING INACTIVE SEWER, WATER, GAS, ELECTRIC AND OTHER UTILITIES, WHICH INTERFERE WITH THE EXECUTION OF THE WORK, SHALL BE REMOVED AND/OR CAPPED, PLUGGED OR OTHERWISE DISCONTINUED AT POINTS WHICH WILL NOT INTERFERE WITH THE EXECUTION OF THE WORK, SUBJECT TO THE APPROVAL OF THE ENGINEER.
- 20. CONTRACTOR SHALL MINIMIZE DISTURBANCE TO EXISTING SITE DURING CONSTRUCTION. EROSION CONTROL MEASURES, IF REQUIRED DURING CONSTRUCTION SHALL BE IN CONFORMANCE WITH JURISDICTIONAL OR STATE AND LOCAL GUIDELINES FOR EROSION AND SEDIMENT CONTROL AND COORDINATED WITH LOCAL REGULATORY AUTHORITIES.
- 21. LIGHT SHADED LINES AND NOTES REPRESENT WORK PREVIOUSLY DONE. DARK SHADED LINES AND NOTES REPRESENT THE SCOPE OF WORK FOR THIS PROJECT. CONTRACTOR SHALL VERIFY IF EXISTING CONSTRUCTION IS COMPLETE. CONTRACTOR SHALL NOTIFY ENGINEER OF ANY EXISTING CONDITIONS THAT DEVIATE FROM THE DRAWINGS PRIOR TO BEGINNING CONSTRUCTION.
- CONTRACTOR SHALL SECURE ALL NECESSARY PERMITS AND/OR WIRING CERTIFICATES REQUIRED FOR THE ELECTRICAL SERVICE UPGRADE. IN ADDITION, CONTRACTOR SHALL PROVIDE ALL NECESSARY COORDINATION AND SCHEDULING WITH THE SERVING ELECTRICAL UTILITY AND LOCAL INSPECTION

# **ELECTRICAL NOTES**

- 1. ELECTRICAL CONTRACTOR SHALL SUPPLY AND INSTALL ANY/ALL ELECTRICAL WORK INDICATED. ANY/ALL CONSTRUCTION SHALL BE IN ACCORDANCE W/DRAWINGS AND ANY/ALL APPLICABLE SPECIFICATIONS. IF ANY PROBLEMS ARE ENCOUNTERED BY COMPLYING WITH THESE REQUIREMENTS, CONTRACTOR SHALL NOTIFY 'CONSTRUCTION MANAGER' AS SOON AS POSSIBLE, AFTER THE DISCOVERY OF THE PROBLEMS, AND SHALL NOT PROCEED WITH THAT PORTION OF WORK, UNTIL THE 'CONSTRUCTION MANAGER' HAS DIRECTED THE CORRECTIVE ACTIONS TO BE TAKEN.
- ELECTRICAL CONTRACTOR SHALL VISIT THE JOB SITE AND FAMILIARIZE HIMSELF WITH ANY/ALL CONDITIONS AFFECTING ELECTRICAL AND COMMUNICATION INSTALLATION AND MAKE PROVISIONS AS TO THE COST THEREOF, ALL EXISTING CONDITIONS OF ELECTRICAL EQUIP, LIGHT FIXTURES, ETC., THAT ARE PART OF THE FINAL SYSTEM, SHALL BE VERIFIED BY THE CONTRACTOR, PRIOR TO THE SUBMITTAL OF HIS BID. FAILURE TO COMPLY WITH THIS PARAGRAPH WILL IN NO WAY RELIEVE CONTRACTOR OF PERFORMING ALL WORK NECESSARY FOR A COMPLETE AND WORKING SYSTEM
- ALL WORK SHALL BE PERFORMED IN ACCORDANCE WITH THE LATEST EDITION OF THE NEC AND ALL CODES AND LOCAL ORDINANCES OF THE LOCAL POWER & TELEPHONE COMPANIES HAVING JURISDICTION AND SHALL INCLUDE BUT NOT BE LIMITED TO:

  - B. NEC NATIONAL ELECTRICAL CODE

  - NEMA NATIONAL ELECTRICAL MANUFACTURERS ASSOC. OSHA OCCUPATIONAL SAFETY AND HEALTH ACT
- SBC STANDARD BUILDING CODE F NEPA - NATIONAL FIRE CODES
- DO NOT SCALE ELECTRICAL DRAWINGS. REFER TO SITE PLANS AND ELEVATIONS FOR EXACT LOCATIONS OF ALL EQUIPMENT, AND CONFIRM WITH 'CONSTRUCTION MANAGER' ANY SIZES AND LOCATIONS WHEN
- 5. EXISTING SERVICES: CONTRACTOR SHALL NOT INTERRUPT EXISTING SERVICES WITHOUT WRITTEN PERMISSION OF THE OWNER.
- CONTRACTOR SHALL PAY FOR ANY/ALL PERMITS FEES INSPECTIONS AND TESTING CONTRACTOR IS TO OBTAIN PERMITS AND APPROVED SUBMITTALS PRIOR TO THE WORK BEGINNING OR ORDERING
- THE TERM "PROVIDE" USED IN CONSTRUCTION DOCUMENTS AND SPECIFICATIONS, INDICATES THAT THE CONTRACTOR SHALL FURNISH AND INSTALL.
- CONTRACTOR SHALL CONFIRM WITH LOCAL UTILITY COMPANY ANY/ALL REQUIREMENTS SUCH AS THE: LUG SIZE RESTRICTIONS, CONDUIT ENTRY, SIZE OF TRANSFORMERS, SCHEDULED DOWNTIME FOR THE OWNERS' CONFIRMATION, ETC. ANY/ALL CONFLICTS SHALL BE BROUGHT TO THE ATTENTION OF THE CONSTRUCTION MANAGER, PRIOR TO BEGINNING ANY WORK.
- MINIMUM WIRE SIZE SHALL BE #12 AWG, NOT INCLUDING CONTROL WIRING, UNLESS NOTED OTHERWISE. ALL CONDUCTORS SHALL BE COPPER WITH THWN INSULATION.
- 10. OUTLET BOXES SHALL BE PRESSED STEEL IN DRY LOCATIONS, CAST ALLOY WITH THREADED HUBS IN WET/DAMP LOCATIONS AND SPECIAL ENCLOSURES FOR OTHER CLASSIFIED AREAS.
- 11. IT IS NOT THE INTENT OF THESE PLANS TO SHOW EVERY MINOR DETAIL OF THE CONSTRUCTION.

  CONTRACTOR IS EXPECTED TO FURNISH AND INSTALL ALL ITEMS FOR A COMPLETE ELECTRICAL

  SYSTEM AND PROVIDE ALL REQUIREMENTS FOR THE EQUIPMENT TO BE PLACED IN PROPER WORKING
- 12. ELECTRICAL SYSTEM SHALL BE AS COMPLETELY AND EFFECTIVELY GROUNDED, AS REQUIRED BY SPECIFICATIONS, SET FORTH BY SPRINT,
- ALL WORK SHALL BE PERFORMED BY A LICENSED ELECTRICAL CONTRACTOR IN A FIRST CLASS, WORKMANLIKE MANNER. THE COMPLETED SYSTEM SHALL BE FULLY OPERATIVE AND SUBJECT TO REGULATORY INSPECTION AND APPROVAL BY CONSTRUCTION MANAGER.
- 14. ALL WORK SHALL BE COORDINATED WITH OTHER TRADES TO AVOID INTERFERENCE WITH THE PROGRESS OF CONSTRUCTION.
- 15. CONTRACTOR SHALL GUARANTEE ANY/ALL MATERIALS AND WORK FREE FROM DEFECTS FOR A PERIOD OF NOT LESS THAN ONE YEAR FROM DATE OF ACCEPTANCE.
- 16. THE CORRECTION OF ANY DEFECTS SHALL BE COMPLETED WITHOUT ANY ADDITIONAL CHARGE AND SHALL INCLUDE THE REPLACEMENT OR THE REPAIR OF ANY OTHER PHASE OF THE INSTALLATION, WHICH MAY HAVE BEEN DAMAGED THEREIN.
- 17. ADEQUATE AND REQUIRED LIABILITY INSURANCE SHALL BE PROVIDED FOR PROTECTION AGAINST PUBLIC LOSS AND ANY/ALL PROPERTY DAMAGE FOR THE DURATION OF WORK.
- 18. PROVIDE AND INSTALL CONDUIT, CONDUCTORS, PULL WIRES, BOXES, COVER PLATES AND DEVICES FOR ALL OUTLETS AS INDICATED.
- 19. DITCHING AND BACK FILL: CONTRACTOR SHALL PROVIDE FOR ALL UNDERGROUND INSTALLED CONDUIT AND/OR CABLES INCLUDING EXCAVATION AND BACKFILLING AND COMPACTION, REFER TO NOTES AND REQUIREMENTS 'EXCAVATION, AND BACKFILLING.
- 20. MATERIALS, PRODUCTS AND EQUIPMENT, INCLUDING ALL COMPONENTS THEREOF, SHALL BE NEW AND SHALL APPEAR ON THE LIST OF U.L. APPROVED ITEMS AND SHALL MEET OR EXCEED THE REQUIREMENTS OF THE NEC, NEMA AND IEEE.
- 21. CONTRACTOR SHALL SUBMIT SHOP DRAWINGS OR MANUFACTURES CATALOG INFORMATION OF ANY/ALL LIGHTING FIXTURES, SWITCHES AND ALL OTHER ELECTRICAL ITEMS FOR APPROVAL BY THE CONSTRUCTION MANAGER PRIOR TO INSTALLATION.
- 22. ANY CUTTING OR PATCHING DEEMED NECESSARY FOR ELECTRICAL WORK IS THE ELECTRICAL CONTRACTORS RESPONSIBILITY AND SHALL BE INCLUDED IN THE COST FOR WORK AND PERFORMED TO THE SATISFACTION OF THE 'CONSTRUCTION MANAGER' UPON FINAL ACCEPTANCE.
- 23. THE ELECTRICAL CONTRACTOR SHALL LABEL ALL PANELS WITH ONLY TYPEWRITTEN DIRECTORIES. ALL ELECTRICAL WIRING SHALL BE THE RESPONSIBILITY OF THE ELECTRICAL CONTRACTOR.
- 24. DISCONNECT SWITCHES SHALL BE H.P. RATED HEAVY-DUTY, QUICK-MAKE AND QUICK-BREAK ENCLOSURES, AS REQUIRED BY EXPOSURE TYPE.
- 25. ALL CONNECTIONS SHALL BE MADE WITH A PROTECTIVE COATING OF AN ANTI-OXIDE COMPOUND SUCH AS "NO-OXIDE A" BY DEARBORNE CHEMICAL CO. COAT ALL WIRE SURFACES BEFORE CONNECTING. EXPOSED COPPER SURFACES, INCLUDING GROUND BARS, SHALL BE TREATED - NO SUBSTITUTIONS.
- 26. ALL EXTERIOR ABOVE GROUND CONDUIT SHALL BE RIGID UNLESS OTHERWISE SPECIFIED. ALL BURIED CONDUITS SHALL BE SCH 40 PVC UNLESS OTHERWISE SPECIFIED. ALL INTERIOR CONDUITS SHALL BE EMT UNLESS OTHERWISE SPECIFIED.
- 27. RACEWAYS: CONDUIT SHALL BE SCHEDULE 40 PVC MEETING OR EXCEEDING NEMA TC2 CONTRACTOR SHALL PLUG AND CAP EACH END OF SPARE AND EMPTY CONDUITS AND PROVIDE TWO SEPARATE PULL STRINGS — 200 LBS TEST POLYETHYLENE CORD. ALL CONDUIT BENDS SHALL BE A MINIMUM OF 2 FT. RADIUS. RGS CONDUITS WHEN SPECIFIED, SHALL MEET LIGH FOR GALVANIZED STEEL. ALL FITTINGS SHALL BE SUITABLE FOR USE WITH THREADED RIGID CONDUIT. COAT ALL THREADS WITH 'BRITE ZINC' OR 'GOLD GALV'.

- 28. SUPPORT OF ALL ELECTRICAL WORK SHALL BE AS REQUIRED BY NEC.
- 29. CONDUCTORS: CONTRACTOR SHALL USE 98% CONDUCTIVITY COPPER WITH TYPE THWN/THHN INSULATION, 600 VOLT, COLOR CODED. UNLESS SPECIFIED DIFFERENT ON DRAWINGS.
- 30. CONNECTORS FOR POWER CONDUCTORS: CONTRACTOR SHALL USE PRESSURE TYPE INSULATED TWIST-ON CONNECTORS FOR NO. 10 AWG AND SMALLER. USE SOLDERLESS MECHANICAL TERMINAL LUGS FOR NO. 8 AWG AND LARGER.
- SERVICE: 240/120V, SINGLE PHASE, 3 WIRE CONNECTION AVAILABLE FROM UTILITY COMPANY. OWNER OR OWNERS AGENT WILL APPLY FOR POWER.
- 32. TELEPHONE SERVICE: CONTRACTOR SHALL PROVIDE EMPTY CONDUITS WITH PULL STRINGS AS INDICATED ON DRAWINGS.
- 33. ELECTRICAL AND TELCO RACEWAYS TO BE BURIED A MINIMUM OF 2' DEPTH.
- 34. CONTRACTOR SHALL PLACE TWO LENGTHS OF WARNING TAPE AT A DEPTH OF 12" BELOW GROUND AND DIRECTLY ABOVE ELECTRICAL AND TELCO SERVICE CONDUITS. CAUTIONS TAPE TO READ "CAUTION BURIED ELECTRIC" OR "BURIED TELECOM".
- 35. WHEN DIRECTIONAL BORING IS REQUIRED, CONTRACTOR SHALL INSTALL A LOOSE TONING WIRE WITHIN INSTALLED CONDUIT TO ALLOW FOR IDENTIFICATION OF UNDERGROUND CONDUITS
- 36. ALL BOLTS SHALL BE STAINLESS STEEL.

### ANTENNA & COAX NOTES

- VERIFY EACH COAXIAL CABLE LENGTH, DIAMETER, ROUTING, COLOR CODING AND ALL APPURTENANCES WITH SAMSUNG.
- THE MAXIMUM COAXIAL CABLE LENGTH AND CORRESPONDING COAXIAL CABLE DIAMETER HAS BEEN ESTIMATED ON SHEET A-4. THIS CABLE LENGTH IS APPROXIMATE, AND IS NOT TO BE USED FOR FABRICATION OR CONSTRUCTION, ACTUAL ANTENNA CABLE LENGTH(S) MAY VARY FROM ESTIMATED MAXIMUM LENGTH AND MUST BE VERIFIED. COAXIAL CABLE SHALL BE
- 3. ALL MAIN CABLES SHALL UTILIZE GROUND KITS, GROUNDED AS FOLLOWS:
  - NEAR ANTENNA RAD CENTER ELEVATION, B. MIDDLE OF TOWER (MID-HEIGHT OF ANTENNA), IF CABLE RUN IS OVER 200',
  - BOTTOM OF TOWER D. AT MASTER GROUND BAR 3'-0" FROM MMBS-BBU CABINET.
- 4. ALL TOP JUMPERS SHALL BE LENGTHS AS SHOWN, SUPPLIED BY SAMSUNG, AND INSTALLED
- ALL MAIN CABLES SHALL BE COLOR CODED AS SHOWN ON SHEET RF-1 AND IN ACCORDANCE
- 6. BANDING SHALL BE IN ACCORDANCE WITH SHEET RF-1 AND AS FOLLOWS:
- A. MAIN LINE COLOR BANDS SHALL BE 2" WIDE. MAINTAIN 1" SPACING BETWEEN COLORS.
  B. FREQUENCY COLOR BANDS SHALL BE 2" WIDE WITH NO SPACE BETWEEN COLORS.
  C. JUMPER COLOR BANDS SHALL BE 1" WIDE WITH 1" SPACE.
- D. START COLOR BANDS 2" BEYOND WEATHERPROOFING. E. START SELECTOR COLOR NEXT TO END CONNECTORS.
- FINAL COAXIAL ANTENNA CABLE SIZES SHALL BE DETERMINED BY SAMSUNG RF ENGINEER. SEE ANTENNA SCHEDULE SHEET A-4.
- SEE CONSTRUCTION MANAGER FOR ANTENNA SUPPORT ASSEMBLY TYPE.
- ALL COAXIAL CABLE WILL BE SECURED TO THE DESIGNED SUPPORT STRUCTURE AT DISTANCES NOT TO EXCEED 3' OR THE CABLE MANUFACTURES SPECIFICATIONS WHICHEVER IS LESS, WITH HARDWARE SPECIFIED IN THE COAXIAL CABLE ROUTING DETAILS OF THE SUPPLIED STRUCTURAL
- 10. PROVIDE AT LEAST 6" OF SLACK IN THE MAIN COAXIAL CABLES AT THE ANTENNA MOUNTING ELEVATION TO PROVIDE FOR FUTURE CONNECTOR REPLACEMENT.











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PROFESSIONAL ENGINEER
I hereby certify that this plan, specification, report was prepared by me or under my directly supervision and that I am a duly Licensed Professional Engineer under the laws of the

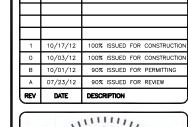MS72XC330-A F1/MN0330-WITHROP 19900 MANNING TRAIL N STILLWATER, MN 55082

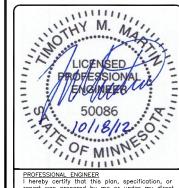SHEET TITLE

**GENERAL NOTES 1** 

SHEET NUMBER

GN-1

# SITE WORK NOTES

- 1. DO NOT EXCAVATE OR DISTURB BEYOND THE PROPERTY LINES OR LEASE LINES, UNLESS OTHERWISE
- 2. DO NOT SCALE BUILDING DIMENSIONS FROM DRAWING.
- SIZE, LOCATION AND TYPE OF ANY UNDERGROUND UTILITIES OR IMPROVEMENTS SHALL BE ACCURATELY NOTED AND PLACED ON AS-BUILT DRAWINGS BY GENERAL CONTRACTOR AND ISSUED TO
- ALL EXISTING UTILITIES, FACILITIES, CONDITIONS AND THEIR DIMENSIONS SHOWN ON PLANS HAVE BEEN PLOTTED FROM AVAILABLE RECORDS. THE ENGINEER AND OWNER ASSUME NO RESPONSIBILITY WHATSOEVER AS TO THE SUFFICIENCY OR ACCURACY OF THE INFORMATION SHOWN ON THE PLAITHE MANNER OF THEIR REMOVAL OR ADJUSTMENT. CONTRACTOR SHALL BE RESPONSIBLE FOR DETERMINING EXACT LOCATION OF ALL EXISTING UTILITIES AND FACILITIES PRIOR TO START OF CONSTRUCTION. CONTRACTOR SHALL ALSO OBTAIN FROM EACH UTILITY COMPANY DETAILED INFORMATION RELATIVE TO WORKING SCHEDULES AND METHODS OF REMOVING OR ADJUSTING EXISTING UTILITIES.
- CONTRACTOR SHALL VERIFY ALL EXISTING UTILITIES BOTH HORIZONTALLY AND VERTICALLY PRIOR TO START OF CONSTRUCTION. ANY DISCREPANCIES OR DOUBTS AS TO THE INTERPRETATION OF PLANS SHALL BE IMMEDIATELY REPORTED TO THE ARCHITECT/ENGINEER FOR RESOLUTION AND INSTRUCTION, AND NO FURTHER WORK SHALL BE PERFORMED UNTIL THE DISCREPANCY IS CHECKED AND CORRECTED BY THE ARCHITECT/ENGINEER. FAILURE TO SECURE SUCH INSTRUCTION MEANS CONTRACTOR WILL HAVE WORKED AT HIS/HER OWN RISK AND EXPENSE. CONTRACTOR SHALL CALL LOCAL DIGGER HOT LINE FOR UTILITY LOCATIONS 48 HOURS PRIOR TO START OF CONSTRUCTION.
- ALL NEW AND EXISTING UTILITY STRUCTURES ON SITE AND IN AREAS TO BE DISTURBED BY CONSTRUCTION SHALL BE ADJUSTED TO FINISH ELEVATIONS PRIOR TO FINAL INSPECTION OF WORK.
- GRADING OF THE SITE WORK AREA IS TO BE SMOOTH AND CONTINUOUS IN SLOPE AND IS TO FEATHER INTO EXISTING GRADES AT THE GRADING LIMITS.
- ALL TEMPORARY EXCAVATIONS FOR THE INSTALLATION OF FOUNDATIONS, UTILITIES, ETC., SHALL BE PROPERLY LAID BACK OR BRACED IN ACCORDANCE WITH CORRECT OCCUPATIONAL SAFETY AND HEALTH
- 9. STRUCTURAL FILLS SUPPORTING PAVEMENTS SHALL BE COMPACTED TO 95% OF MAXIMUM STANDARD
- 10. NEW GRADES NOT IN BUILDING AND DRIVEWAY IMPROVEMENT AREA TO BE ACHIEVED BY FILLING WITH APPROVED CLEAN FILL AND COMPACTED TO 95% OF STANDARD PROCTOR DENSITY
- 11. ALL FILL SHALL BE PLACED IN UNIFORM LIFTS. THE LIFTS THICKNESS SHOULD NOT EXCEED THAT WHICH CAN BE PROPERLY COMPACTED THROUGHOUT ITS ENTIRE DEPTH WITH THE EQUIPMENT AVAILABLE.
- 12. ANY FILLS PLACED ON EXISTING SLOPES THAT ARE STEEPER THAN 10 HORIZONTAL TO 1 VERTICAL SHALL BE PROPERLY BENCHED INTO THE EXISTING SLOPE AS DIRECTED BY A GEOTECHNICAL ENGINEER.
- 13. CONTRACTOR SHALL CLEAN ENTIRE SITE AFTER CONSTRUCTION SUCH THAT NO PAPERS, TRASH, WEEDS, BRUSH OR ANY OTHER DEPOSITS WILL REMAIN. ALL MATERIALS COLLECTED DURING CLEANING OPERATIONS SHALL BE DISPOSED OF OFF-SITE BY THE GENERAL CONTRACTOR
- 14. ALL TREES AND SHRUBS WHICH ARE NOT IN DIRECT CONFLICT WITH THE IMPROVEMENTS SHALL BE PROTECTED BY THE GENERAL CONTRACTOR.
- ALL SITE WORK SHALL BE CAREFULLY COORDINATED BY GENERAL CONTRACTOR WITH LOCAL UTILITY COMPANY, TELEPHONE COMPANY, AND ANY OTHER UTILITY COMPANIES HAVING JURISDICTION OVER THIS

# **ENVIRONMENTAL NOTES**

- ALL WORK PERFORMED SHALL BE DONE IN ACCORDANCE WITH ISSUED PERMITS. THE CONTRACTOR SHALL BE RESPONSIBLE FOR PAYMENT OF FINES AND PROPER CLEAN UP FOR AREAS IN VIOLATION.
- CONTRACTOR AND/OR DEVELOPER SHALL BE RESPONSIBLE FOR CONSTRUCTION AND MAINTENANCE OF EROSION AND SEDIMENTATION CONTROLS DURING CONSTRUCTION FOR PROTECTION OF ADJACENT PROPERTIES, ROADWAYS AND WATERWAYS AND SHALL BE MAINTAINED IN PLACE THROUGH FINAL JURISDICTIONAL INSPECTION & RELEASE OF SITE
- 3. CONTRACTOR SHALL INSTALL/CONSTRUCT ALL NECESSARY SEDIMENT/SILT CONTROL FENCING AND PROTECTIVE MEASURES WITHIN THE LIMITS OF SITE DISTURBANCE PRIOR TO CONSTRUCTION
- NO SEDIMENT SHALL BE ALLOWED TO EXIT THE PROPERTY. THE CONTRACTOR IS RESPONSIBLE FOR TAKING ADEQUATE MEASURES FOR CONTROLLING EROSION. ADDITIONAL SEDIMENT CONTROL FENCING MAY BE REQUIRED IN ANY AREAS SUBJECT TO EROSION.
- 5. THE CONTRACTOR IS RESPONSIBLE FOR MAINTAINING POSITIVE DRAINAGE ON THE SITE AT ALL TIMES WITH SILT AND EROSION CONTROL MEASURES MAINTAINED ON THE DOWNSTREAM SIDE OF SITE DRAINAGE. ANY DAMAGE TO ADJACENT PROPERTY AS A RESULT OF EROSION WILL BE CORRECTED AT
- CONTRACTOR SHALL BE RESPONSIBLE FOR DAILY INSPECTIONS AND ANY REPAIRS OF ALL SEDIMENT CONTROL MEASURES INCLUDING SEDIMENT REMOVAL AS NECESSARY.
- CLEARING OF VEGETATION AND TREE REMOVAL SHALL BE ONLY AS PERMITTED AND BE HELD TO A MINIMUM. ONLY TREES NECESSARY FOR CONSTRUCTION OF THE FACILITIES SHALL BE REMOVED
- SFFDING AND MULICHING AND/OR SODDING OF THE SITE WILL BE ACCOMPLISHED AS SOON AS POSSIBLE AFTER COMPLETION OF THE PROJECT FACILITIES AFFECTING LAND DISTURBANCE.
- CONTRACTOR SHALL PROVIDE ALL EROSION AND SEDIMENTATION CONTROL MEASURES AS REQUIRED BY LOCAL, COUNTY AND STATE CODES AND ORDINANCES TO PROTECT EMBANKMENTS FROM SOIL LOSS AND TO PREVENT ACCUMULATION OF SOIL AND SILT IN STREAMS AND DRAINAGE PATHS LEAVING TH CONSTRUCTION AREA. THIS MAY INCLUDE SUCH MEASURES AS SILT FENCES. STRAW BALE SEDIMENT BARRIERS, AND CHECK DAMS.
- 10. RIP RAP OF SIZES INDICATED SHALL CONSIST OF CLEAN, HARD, SOUND, DURABLE, UNIFORM IN QUALITY STONE FREE OF ANY DETRIMENTAL QUANTITY OF SOFT, FRIABLE, THIN, ELONGATED OR LAMINATED PIECES, DISINTEGRATED MATERIAL, ORGANIC MATTER, OIL, ALKALI, OR OTHER DELETERIOUS

# FOUNDATION, EXCAVATION AND BACKFILL NOTES

- 1. ALL FINAL GRADED SLOPES SHALL BE A MAXIMUM OF 3 HORIZONTAL TO 1 VERTICAL.
- 2. ALL EXCAVATIONS PREPARED FOR PLACEMENT OF CONCRETE SHALL BE OF UNDISTURBED SOILS, SUBSTANTIALLY HORIZONTAL AND FREE FROM ANY LOOSE, UNSUITABLE MATERIAL OR FROZEN SOILS, AND WITHOUT THE PRESENCE OF POUNDING WATER. DEWATERING FOR EXCESS GROUND WATER SHALL BE PROVIDED WHEN REQUIRED. COMPACTION OF SOILS UNDER CONCRETE PAD FOUNDATIONS SHALL NOT BE LESS THAN 95% OF THE MODIFIED PROCTOR MAXIMUM DRY DENSITY FOR THE SOIL IN
- 3. CONCRETE FOUNDATIONS SHALL NOT BE PLACED ON ORGANIC OR UNSUITABLE MATERIAL. IF INADEQUATE BEARING CAPACITY IS REACHED AT THE DESIGNED EXCAVATION DEPTH, THE UNSATISFACTORY SOIL SHALL BE EXCAVATED TO ITS FULL DEPTH AND EITHER BE REPLACED WITH MECHANICALLY COMPACTED GRANULAR MATERIAL OR THE EXCAVATION SHALL BE FILLED WITH CONCRETE OF THE SAME TYPE SPECIFIED FOR THE FOUNDATION. CRUSHED STONE MAY BE USED TO STABILIZE THE BOTTOM OF THE EXCAVATION, ANY STONE SUB BASE MATERIAL, IF USED, SHALL NOT SUBSTITUTE FOR REQUIRED THICKNESS OF CONCRETE.
- 4. ALL EXCAVATIONS SHALL BE CLEAN OF UNSUITABLE MATERIAL SUCH AS VEGETATION, TRASH, DEBRIS AND SO FORTH PRIOR TO BACK FILLING. BACK FILL SHALL CONSIST OF APPROVED MATERIALS SUCH AS EARTH, LOAM, SANDY CLAY, SAND AND GRAVEL, OR SOFT SHALE, FREE FROM CLODS OR LARGE STONES OVER 2 1/2" MAX DIMENSIONS. ALL BACK FILL SHALL BE PLACED IN COMPACTED LAYERS.
- ALL FILL MATERIALS AND FOUNDATION BACK FILL SHALL BE PLACED IN MAXIMUM 6" THICK LIFTS BEFORE COMPACTION. EACH LIFT SHALL BE WETTED IF REQUIRED AND COMPACTED TO NOT LESS THAN 95% OF THE MODIFIED PROCTOR MAXIMUM DRY DENSITY FOR SOIL IN ACCORDANCE WITH ASTM
- 6. NEWLY PLACED CONCRETE FOUNDATIONS SHALL CURE A MINIMUM OF 72 HRS PRIOR TO BACK
- 7 FINISHED GRADING SHALL BE SLOPED TO PROVIDE POSITIVE DRAINAGE AND PREVENT STANDING WATER. THE FINAL (FINISH) ELEVATION OF SLAB FOUNDATIONS SHALL SLOPE AWAY IN ALL DIRECTIONS FROM THE CENTER FINISH GRADE OF CONCRETE PADS SHALL BE A MAXIMUM OF 4" ABOVE FINAL FINISH GRADE ELEVATIONS. PROVIDE SURFACE FILL GRAVEL TO ESTABLISH SPECIFIED ELEVATIONS WHERE REQUIRED.
- 8. NEWLY GRADED SURFACE AREAS TO RECEIVE GRAVEL SHALL BE COVERED WITH GEOTEXTILE FABRIC TYPE: TYPAR-3401 AS MANUFACTURED BY "CONSTRUCTION MATERIAL 1-800-239-3841" OR AN APPROVED EQUIVALENT, SHOWN ON PLANS. THE GEOTEXTILE FABRIC SHALL BE BLACK IN COLOR TO CONTROL THE RECURRENCE OF VEGETATIVE GROWTH AND EXTEND TO WITHIN 1 FOOT OUTSIDE THE SITE FENCING OR ELECTRICAL GROUNDING SYSTEM PERIMETER WHICH EVER IS GREATER. ALL FABRIC SHALL BE COVERED WITH A MINIMUM OF 4" DEEP COMPACTED STONE OR GRAVEL AS SPECIFIED. I.E. TYPE No. 57 FOR FENCED COMPOUND; FDOT TYPE No. 67 FOR ACCESS DRIVE AREA.
- 9. IN ALL AREAS TO RECEIVE FILL, REMOVE ALL VEGETATION, TOPSOIL, DEBRIS, WET AND UNSATISFACTORY SOIL MATERIALS, OBSTRUCTIONS, AND DELETERIOUS MATERIALS FROM GROUND SURFACE. PLOW STRIP OR BREAK UP SLOPED SURFACES STEEPER THAN 1 VERTICAL TO 4 HORIZONTAL SUCH THAT FILL MATERIAL WILL BIND WITH EXISTING/PREPARED SOIL SURFACE
- 10. WHEN SUB GRADE OR PREPARED GROUND SURFACE HAS A DENSITY LESS THAN THAT REQUIRED FOR THE FILL MATERIAL, SCARIFY THE GROUND SURFACE TO DEPTH REQUIRED, PULVERIZE, MOISTURE-CONDITION AND/OR AERATE THE SOILS AND RECOMPACT TO THE REQUIRED DENSITY PRIOR
- 11. IN AREAS WHICH EXISTING GRAVEL SURFACING IS REMOVED OR DISTURBED DURING CONSTRUCTION OPERATIONS, REPLACE GRAVEL SURFACING TO MATCH ADJACENT GRAVEL SURFACING AND RESTORED TO THE SAME THICKNESS AND COMPACTION AS SPECIFIED. ALL RESTORED GRAVEL SURFACING SHALL BE FREE FROM CORRUGATIONS AND WAVES.
- 12. EXISTING GRAVEL SURFACING MAY BE EXCAVATED SEPARATELY AND REUSED WITH THE CONDITION THAT ANY UNFAVORABLE AMOUNTS OF ORGANIC MATTER, OR OTHER DELETERIOUS MATERIALS ARE REMOVED PRIOR TO REUSE. FURNISH ANY ADDITIONAL GRAVEL RESURFACING MATERIAL AS NEEDED TO PROVIDE A FULL DEPTH COMPACTED SURFACE THROUGHOUT SITE.
- 13. GRAVEL SUB SURFACE SHALL BE PREPARED TO REQUIRED COMPACTION AND SUB GRADE ELEVATIONS BEFORE GRAVEL SURFACING IS PLACED AND/OR RESTORED. ANY LOOSE OR DISTURBED MATERIALS SHALL BE THOROUGHLY COMPACTED AND ANY DEPRESSIONS IN THE SUB GRADE SHALL BE FILLED AND COMPACTED WITH APPROVED SELECTED MATERIAL. GRAVEL SURFACING MATERIAL SHALL NOT BE USED FOR FILLING DEPRESSIONS IN THE SUB GRADE.
- 14. PROTECT EXISTING GRAVEL SURFACING AND SUB GRADE IN AREAS WHERE EQUIPMENT LOADS WILL OPERATE. USE PLANKING 'MATTS' OR OTHER SUITABLE PROTECTION DESIGNED TO SPREAD EQUIPMENT LOADS AS MAY BE NECESSARY. REPAIR ANY DAMAGE TO EXISTING GRAVEL SURFACING OR SUB GRADE WHERE SUCH DAMAGE IS DUE TO THE CONTRACTORS OPERATIONS.
- 15. DAMAGE TO EXISTING STRUCTURES AND/OR UTILITIES RESULTING FROM CONTRACTORS NEGLIGENCE SHALL BE REPAIRED AND/OR REPLACED TO THE OWNERS SATISFACTION AT NO ADDITIONAL COST TO
- 16. ALL SUITABLE BORROW MATERIAL FOR BACK FILL OF THE SITE SHALL BE INCLUDED IN THE BID. EXCESS TOPSOIL AND UNSUITABLE MATERIAL SHALL BE DISPOSED OF OFF SITE AT LOCATIONS APPROVED BY GOVERNING AGENCIES AT NO ADDITIONAL COST TO THE CONTRACT.

# STRUCTURAL STEEL NOTES

ALL STEEL WORK SHALL BE IN ACCORDANCE WITH THE LATEST EDITION OF THE AISC MANUAL OF STEEL CONSTRUCTION. STEEL SECTIONS SHALL BE IN ACCORDANCE WITH ASTM AS INDICATED BELOW:

W-SHAPES: ASTM A992, 50 KSI ANGLES, BARS CHANNELS: ASTM A36, 36 KSI HSS SECTIONS: ASTM 500, 46 KSI PIPE SECTIONS: ASTM A53-E, 35 KSI

- 2. ALL EXTERIOR EXPOSED STEEL AND HARDWARE SHALL BE HOT DIPPED GALVANIZED
- ALL WELDING SHALL BE PERFORMED USING E70XX ELECTRODES AND WELDING SHALL CONFORM TO AISC. WHERE FILLET WELD SIZES ARE NOT SHOWN, PROVIDE THE MINIMUM SIZE PER TABLE J2.4 IN THE AISC "MANUAL OF STEEL CONSTRUCTION". PAINTED SURFACES SHALL BE TOUCHED UP
- 4. BOLTED CONNECTIONS SHALL BE ASTM A325 BEARING TYPE (3/4"Ø) CONNECTIONS AND SHALL HAVE MINIMUM OF TWO BOLTS UNLESS NOTED OTHERWISE
- 5. NON-STRUCTURAL CONNECTIONS FOR STEEL GRATING MAY USE 5/8" DIA. ASTM A307 BOLTS
- 6. FIELD MODIFICATIONS ARE TO BE COATED WITH ZINC ENRICHED PAINT.

### CONCRETE MASONRY NOTES

- CONCRETE MASONRY UNITS SHALL BE MEDIUM WEIGHT UNITS CONFORMING TO ASTM C90, GRADE N-1, (F'M=1,500 PS). MEDIUM WEIGHT (115 PCF).
- 2. MORTAR SHALL BE TYPE "S" (MINIMUM 1,800 PSI AT 28 DAYS).
- 3. GROUT SHALL HAVE A MINIMUM COMPRESSIVE STRENGTH OF 3,000 PSI AT 28 DAYS.
- ALL CELLS CONTAINING REINFORCING STEEL OR EMBEDDED ITEMS AND ALL CELLS IN RETAINING WALLS AND WALLS BELOW GRADE SHALL BE SOLID GROUTED.
- 5. ALL HORIZONTAL REINFORCEMENT SHALL BE PLACED IN BOND BEAM OR LINTEL BEAM UNITS.
- 6. WHEN GROUTING IS STOPPED FOR ONE HOUR OR LONGER, HORIZONTAL CONSTRUCTION JOINTS SHALL BE FORMED BY STOPPING THE GROUT POUR 1-1/2" BELOW TOP OF THE
- 7. ALL BOND BEAM BLOCK SHALL BE "DEEP CUT" UNITS.
- PROVIDE INSPECTION AND CLEAN-OUT HOLES AT BASE OF VERTICAL CELLS HAVING GROUT LIFTS IN EXCESS OF 4'-0" OF HEIGHT.
- ALL GROUT SHALL BE CONSOLIDATED WITH A MECHANICAL VIBRATOR.
- 10. CEMENT SHALL BE AS SPECIFIED FOR CONCRETE.
- 11. REINFORCING BARS SEE NOTES UNDER "STRUCTURAL CONCRETE NOTES" FOR
- 12. PROVIDE ONE BAR DIAMETER (A MINIMUM OF 1/2") GROUT BETWEEN MAIN REINFORCING AND
- 13. LOW LIFT CONSTRUCTION, MAXIMUM GROUT POUR HEIGHT IS 4 FEET.
- HIGH LIFT GROUTED CONSTRUCTION MAY BE USED IN CONFORMANCE WITH PROJECT SPECIFICATIONS AND SECTION 2104.6.1. OF U.B.C.
- 15. ALL CELLS IN CONCRETE BLOCKS SHALL BE FILLED SOLID WITH GROUT, EXCEPT AS NOTED IN
- 16. CELLS SHALL BE IN VERTICAL ALIGNMENT, DOWELS IN FOOTINGS SHALL BE SET TO ALIGN WITH CORES CONTAINING REINFORCING STEEL.
- 17. REFER TO ARCHITECTURAL DRAWINGS FOR SURFACE AND HEIGHT OF UNITS, LAYING PATTERN
- SAND SHALL BE CLEAN, SHARP AND WELL GRADED, FREE FROM INJURIOUS AMOUNTS OF DUST, LUMPS, SHALE, ALKAU OR ORGANIC MATERIAL.
- 19. BRICK SHALL CONFORM TO ASTM C-62 AND SHALL BE GRADE MW OR BETTER.

### STRUCTURAL CONCRETE NOTES

CONCRETE CAST AGAINST EARTH....

BEAMS AND COLUMNS.....

- ALL CONCRETE WORK SHALL BE IN ACCORDANCE WITH THE ACI 301-05, ACI 318-05 AND THE SPECIFICATION FOR CAST-IN-PLACE CONCRETE.
- 2. ALL CONCRETE SHALL HAVE A MINIMUM COMPRESSIVE STRENGTH fc'=3,000 PSI AT 28 DAYS
- REINFORCING STEEL SHALL CONFORM TO ASTM A 615, GRADE 60, DEFORMED UNLESS NOTED OTHERWISE. WELDED WIRE FABRIC SHALL CONFORM TO ASTM A 185 WELDED STEEL WIRE FABRIC UNLESS NOTED OTHERWISE. SPLICES CLASS "B" AND ALL HOOKS SHALL BE STANDARD UNLESS NOTED OTHERWISE.
- 4. THE FOLLOWING MINIMUM CONCRETE COVER SHALL BE PROVIDED FOR REINFORCING STEEL UNLESS SHOWN OTHERWISE ON DRAWINGS:

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CONCRETE EXPOSED TO EARTH OR WEATHER:
#6 AND LARGER.....
CONCRETE NOT EXPOSED TO EARTH OR WEATHER OR NOT CAST AGAINST THE GROUND:
                   .....3/4 IN.
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- .....1-1/2 IN. A 3/4" CHAMFER SHALL BE PROVIDED AT ALL EXPOSED EDGES OF CONCRETE U.N.O. IN ACCORDANCE WITH ACI 301 SECTION 4.2.4.
- HOLES TO RECEIVE EXPANSION/WEDGE ANCHORS SHALL BE 1/8" LARGER IN DIAMETER THAN THE ANCHOR BOLT, DOWEL OR ROD AND SHALL CONFORM TO MANUFACTURER'S RECOMMENDATION FOR EMBEDMENT DEPTH OR AS SHOWN ON THE DRAWINGS. LOCATE AND AVOID CUTTING EXISTING REBAR WHEN DRILLING HOLES IN ELEVATED CONCRETE SLABS.
- 7. USE AND INSTALLATION OF CONCRETE EXPANSION/WEDGE ANCHOR, SHALL BE PER ICBO &









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**BLACK & VEATCH** 

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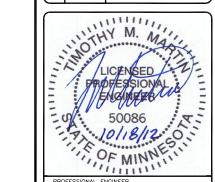
0 10/03/12 100% ISSUED FOR CONSTRUCTION

B 10/01/12 90% ISSUED FOR PERMITTING

90% ISSUED FOR REVIEW

PROJECT NO:

07/23/12



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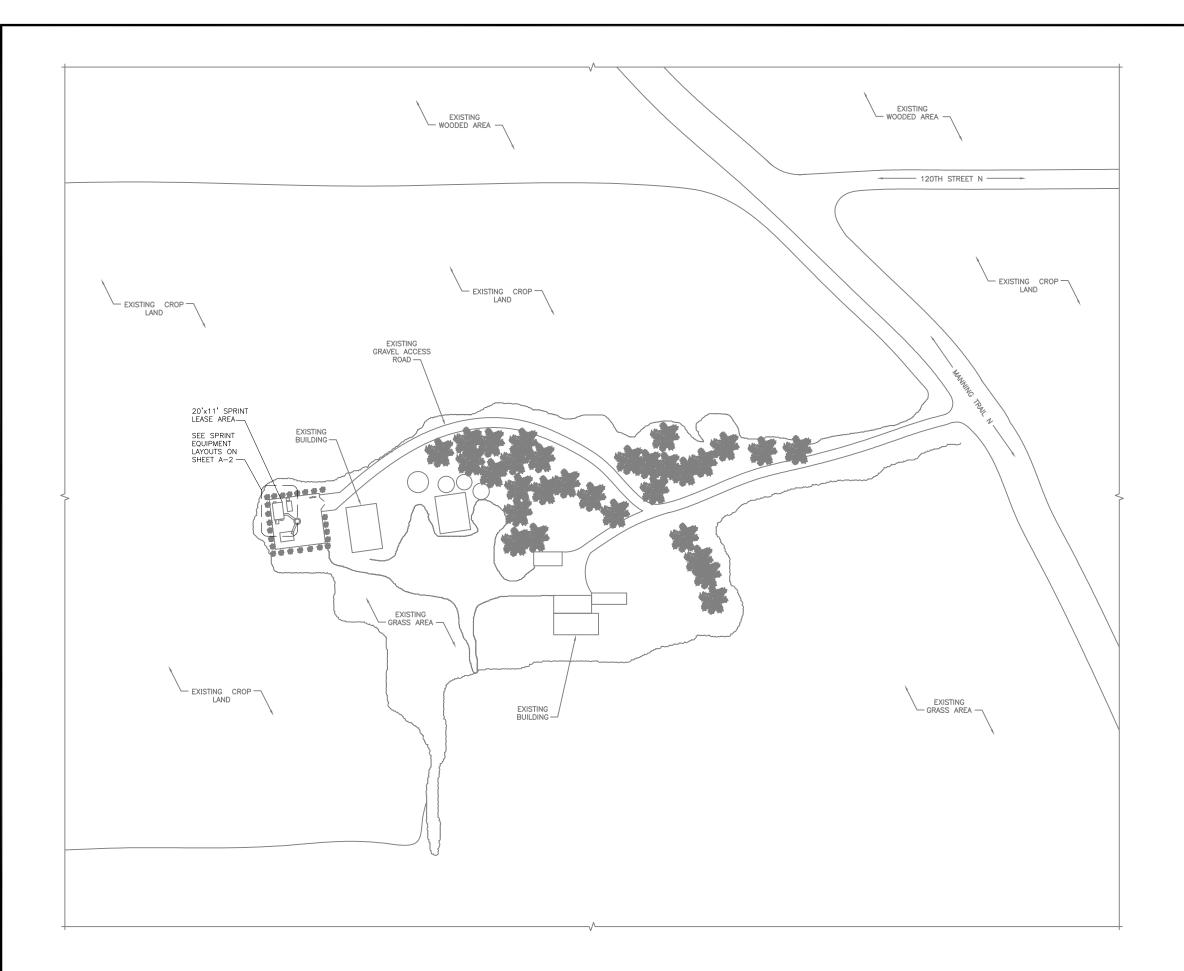
MS72XC330-A F1/MN0330-WITHROP 19900 MANNING TRAIL N STILLWATER, MN 55082

SHFFT TITLE

**GENERAL NOTES 2** 

SHEET NUMBER

GN-2









# **BLACK & VEATCH**



PROJECT NO: 172	
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REV	DATE	DESCRIPTION
Α	07/23/12	90% ISSUED FOR REVIEW
В	10/01/12	90% ISSUED FOR PERMITTING
0	10/03/12	100% ISSUED FOR CONSTRUCTION
1	10/17/12	100% ISSUED FOR CONSTRUCTION
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SHEET TITLE


OVERALL SITE PLAN

SHEET NUMBER

A-1



SCALE: N.T.S.

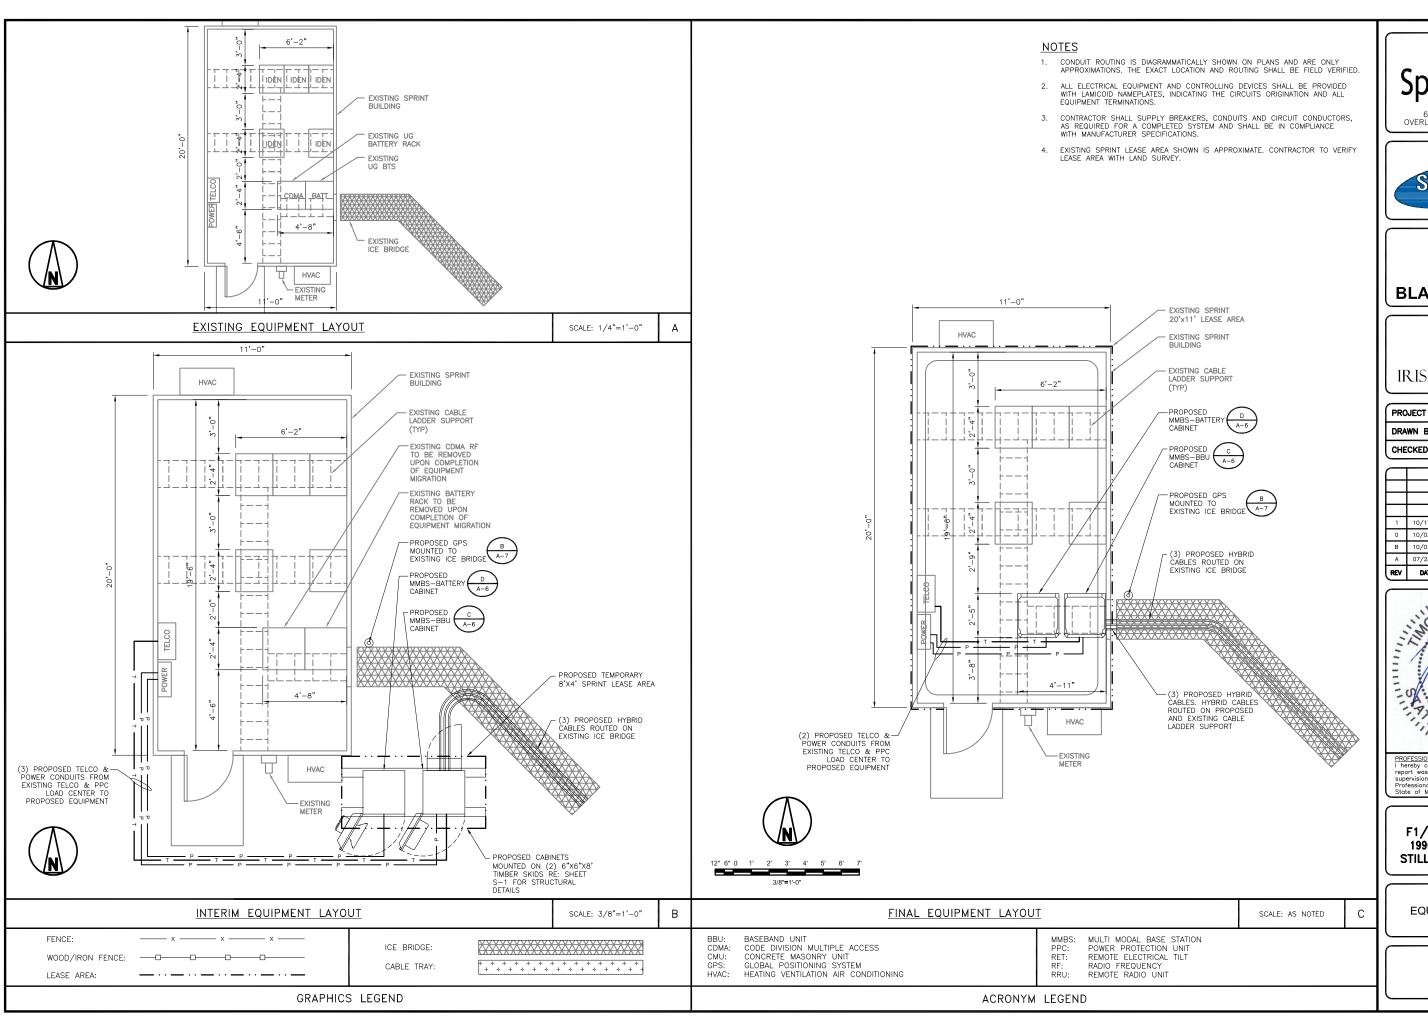









PROJECT NO:	172862
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Α	07/23/12	90% ISSUED FOR REVIEW
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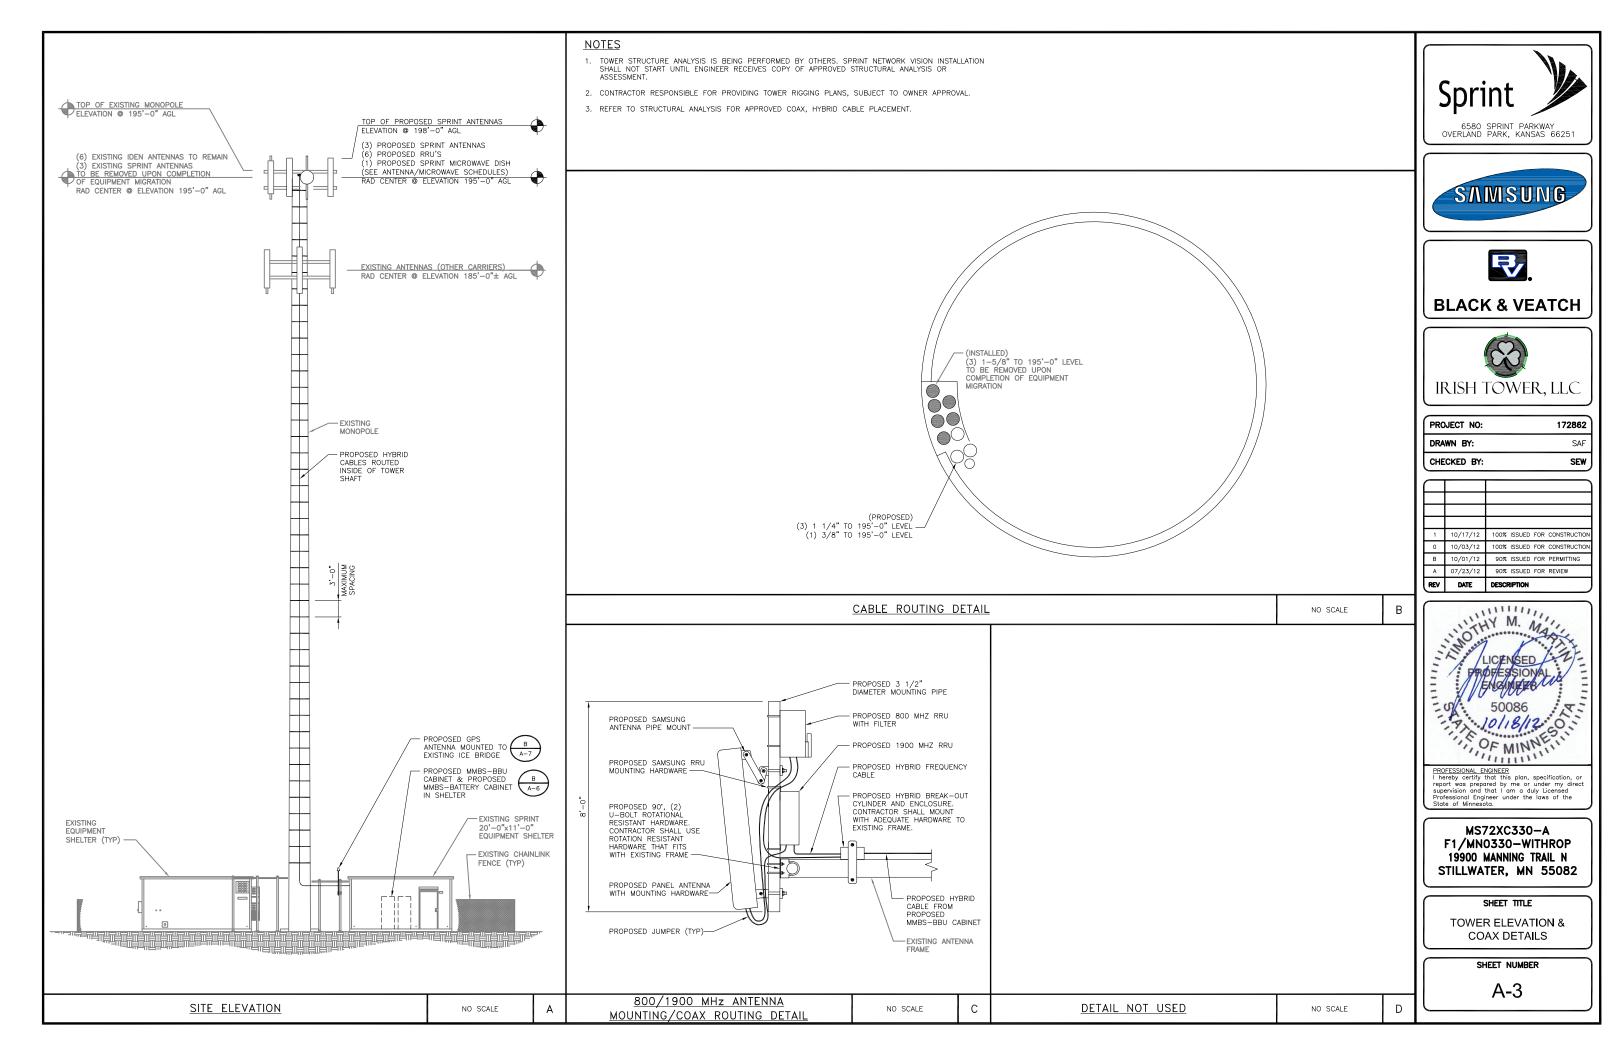
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SHEET TITLE

EQUIPMENT LAYOUTS

SHEET NUMBER

A-2




	PROPOSED ANTENNA SCHEDULE																	
SECTOR	ANTENNA NUMBER	ANTENNA MANUFACTURER	ANTENNA MODEL	NUMBER OF HYBRID CABLES	AZIMUTH	RAD CENTER	ANTENNA GAIN	ELECT D-TILT	MECH TILT	EFF D-TILT	RRU MODEL	RRU FILTER	HYBRID CABLE LENGTH				RET CABLE MANUFACTURER	RET CABLE MODEL NUMBER
1C	800/1900 MHz	POWERWAVE	P90-15-XLPP-RR	SAMSUNG HFC 1 (PER SECTOR)	0,	195'	14.5/16.8	3/1	0/0	3/1	RRH-C2A & RRH-P4	(1) 800 MHz FILTER	270'	1/2"	6'	9.8'	COMMSCOPE	ATCB-B01-003
2D	800/1900 MHz	POWERWAVE	P90-15-XLPP-RR	SAMSUNG HFC 1 (PER SECTOR)	120*	195'	14.5/16.8	2/6	0/0	2/6	RRH-C2A & RRH-P4	(1) 800 MHz FILTER	270'	1/2"	6'	9.8'	COMMSCOPE	ATCB-B01-003
3C	800/1900 MHz	POWERWAVE	P90-15-XLPP-RR	SAMSUNG HFC 1 (PER SECTOR)	240*	195'	14.5/16.8	7/5	0/0	7/5	RRH-C2A & RRH-P4	(1) 800 MHz FILTER	270'	1/2"	6'	9.8'	COMMSCOPE	ATCB-B01-003
-	GPS	PCTEL	GPS-TMG-HR-26NCM	1	-	_	-	-	-	-	-	-	-	1/2" (PCTEL LMR-400)	10'	-	_	-


### NOTES


- 1. EXISTING ANTENNAS ARE CDMA UNLESS NOTED OTHERWISE.
- DIMENSIONS OF EXISTING ANTENNAS SPACING OR PLATFORMS ARE APPROXIMATE. CONTRACTOR SHALL FIELD VERIFY PRIOR TO START OF CONSTRUCTION (SEE GENERAL NOTES, SHEETS GN-1 AND GN-2).
- PROPOSED SPRINT ANTENNAS INCLUDE RESPECTIVE RRU'S WHICH SHALL BE MOUNTED ON THE PIPE BEHIND THE ANTENNA SIMILAR TO THAT SHOWN ON DETAIL C, SHEET A-3.
- FIELD TO VERIFY EXISTING AZIMUTH BEFORE RELOCATING THE ANTENNA, IF REQUIRED. PRIOR APPROVAL FROM SPRINT TO BE GRANTED BEFORE RELOCATION OF ANTENNAS.
- 5. FOR HYBRID CABLE DIAMETER REFER TO HYBRID CABLE TYPE DETAIL ON SHEET E-2, DETAIL C. SIZE WILL VARY BASED ON LENGTH OF RUN.
- 6. EFFECTIVE TILT = MECHANICAL TILT + ELECTRICAL TILT.

	PROPOSED MICROWAVE DISH SCHEDULE												
SECTOR	DISH	PATH	MICROWAVE MODEL	(GHz)	ODU		AZIMUTH	RAD	DIAMETER	COAX			PIPE MOUNT
SECTOR	NUMBER	NUMBER	MICROWAVE MODEL	(6112)	QUANTITY	MODEL	AZIMUTH	CENTER	DIAMETER	NUMBER	SIZE	LENGTH	O.D.
2B	MICROWAVE (1)	MC70V0000	VHLP2-11W (TR)	1.1	1	QUANTUM	101.31°	195'	2'-0"	1	LMR 400 3/8"	270'	3.5"

# ANTENNA/MICROWAVE SCHEDULES

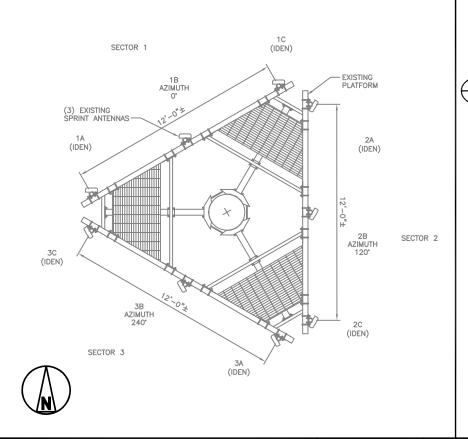

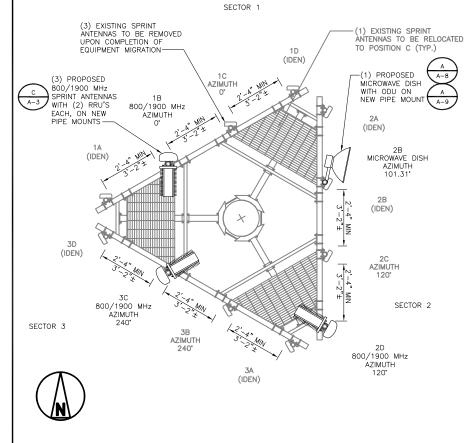

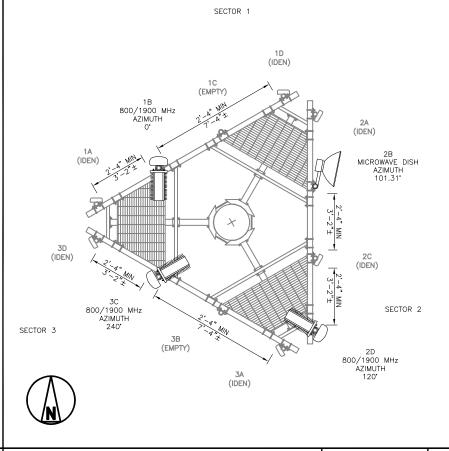









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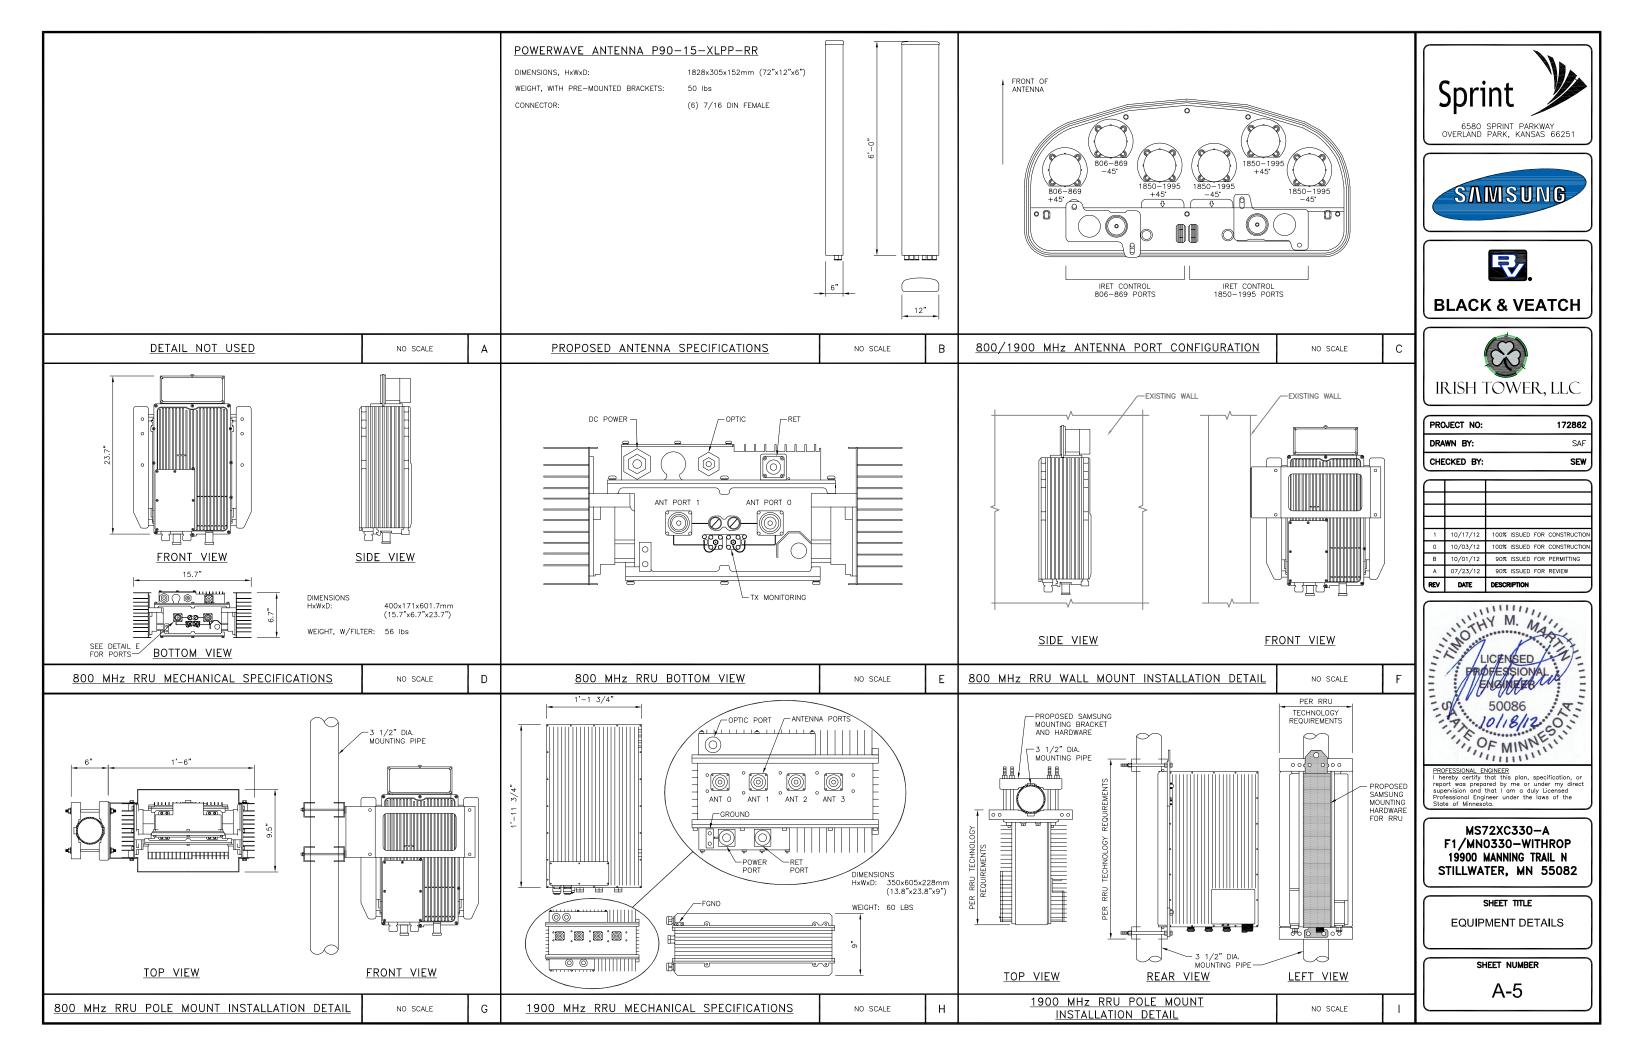
SHEET TITLE


ANTENNA / MICROWAVE SCHEDULE & LAYOUTS


SHEET NUMBER

A-4

EXISTING ANTENNA LAYOUT NO SCALE A INTERIM ANTENNA LAYOUT NO SCALE B FINAL ANTENNA LAYOUT NO SCALE C



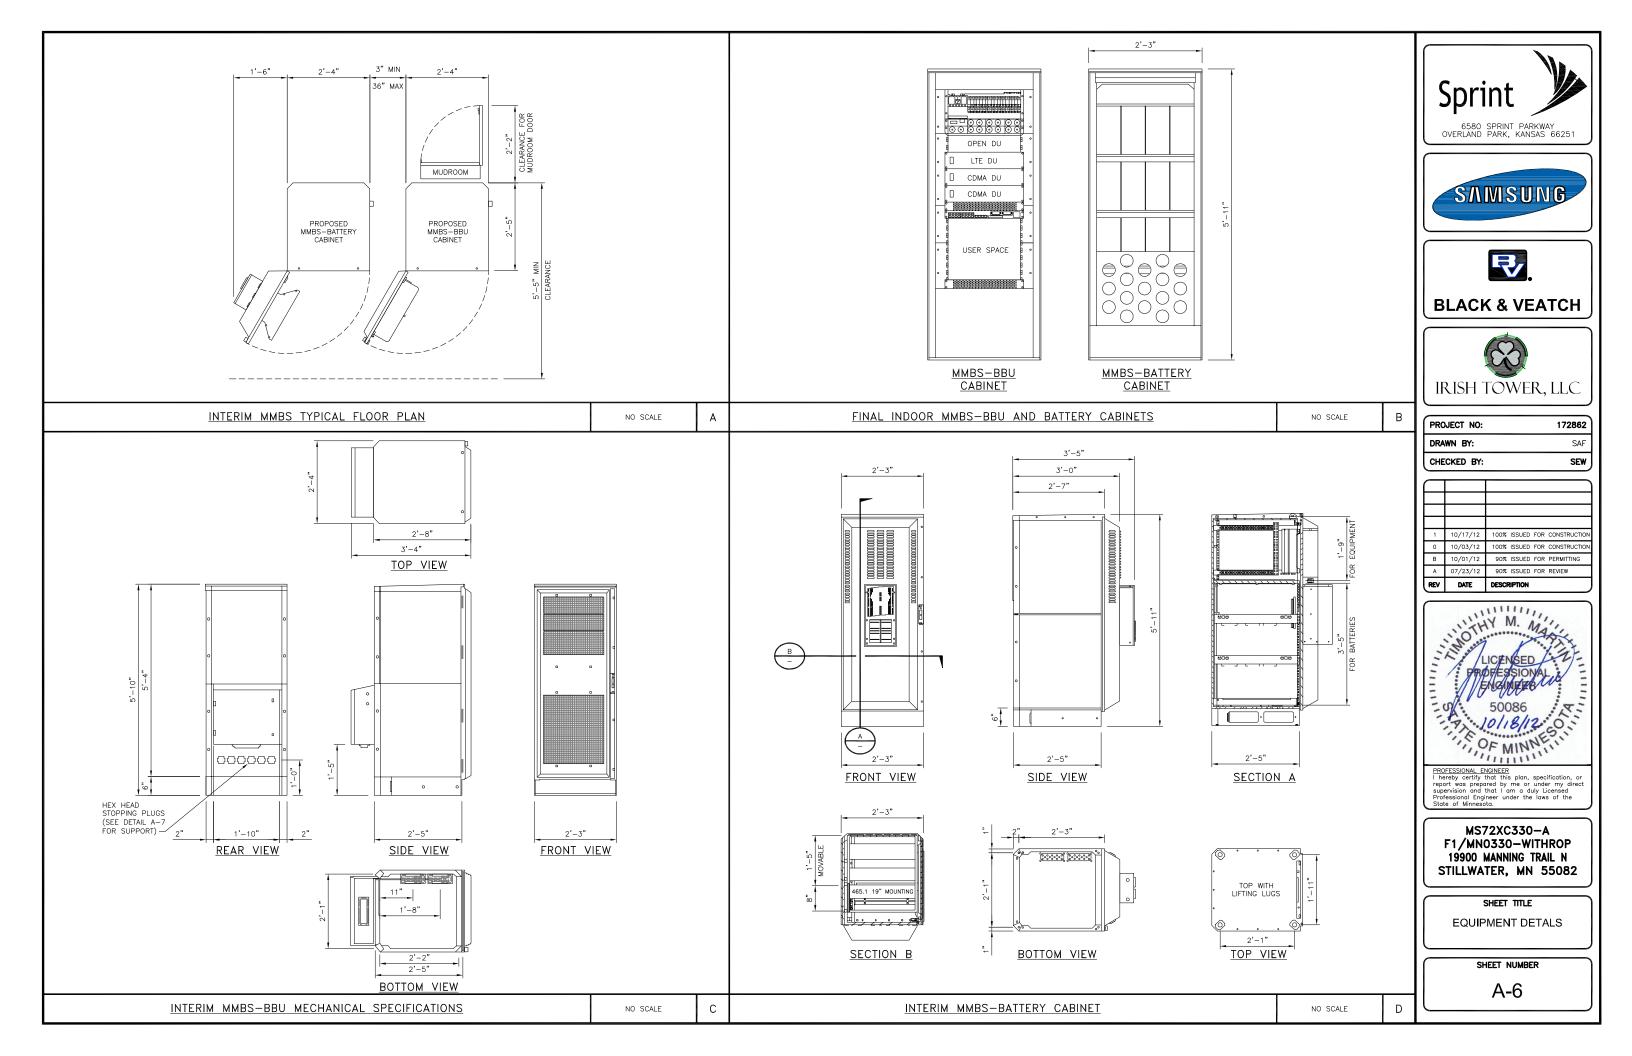


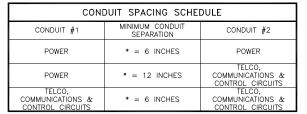


# <u>NOTES</u>

- MULTIPLE CONDUITS CAN BE PLACED IN THE SAME TRENCH AS LONG AS A MINIMUM SEPARATION PER THE LOCAL UTILITY COMPANIES IS MAINTAINED.
- . CONTRACTOR SHALL RESTORE THE TRENCH TO ITS ORIGINAL CONDITIONS BY EITHER SEEDING OR SODDING CRASS AREAS, OR REPLACING ASPHALT OR CONCRETE AREAS TO ITS ORIGINAL CROSS SECTION.

NO SCALE

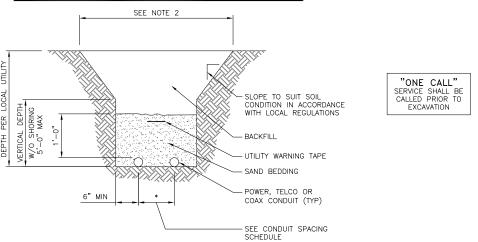

TYPICAL UTILITY TRENCH DETAIL

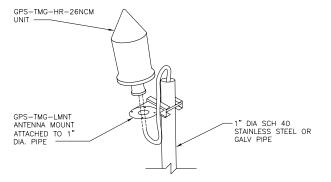


# <u>NOTES</u>

- THE GPS ANTENNA MOUNT IS DESIGNED TO FASTEN TO A STANDARD 1" DIAMETER, SCHEDULE 40, GALVANIZED STEEL OR STAINLESS STEEL PIPE. THE PIPE MUST NOT BE THREADED AT THE ANTENNA MOUNT END. THE PIPE SHALL BE CUT TO THE REQUIRED LENGTH (MINIMUM OF 18 INCHES, 8'-0" IF MOUNTING TO PROPOSED MMBS-BBU) USING A HAND OR ROTARY PIPE CUTTER TO ASSURE A SMOOTH AND PERPENDICULAR CUT. A HACK SAW SHALL
- NOT BE USED. THE CUT PIPE END SHALL BE DEBURRED.
- IT IS CRITICAL THAT THE GPS ANTENNA IS MOUNTED SUCH THAT IT IS WITHIN 2
  DEGREES OF VERTICAL AND THE BASE OF THE ANTENNA IS WITHIN 2 DEGREES OF
  LEVEL.
- 3. DO NOT SWEEP TEST GPS ANTENNA.

**GPS UNIT PIPE MOUNT** 

4. ATTACH GPS MOUNTING PIPE TO PROPOSED MMBS-BBU USING (4) 8MMx15MM SS BOLTS AND (4) 1" PIPE STRAPS. GPS TO BE MOUNTED A MINIMUM OF 2'-0" ABOVE PROPOSED MMBS-BBU CABINET.

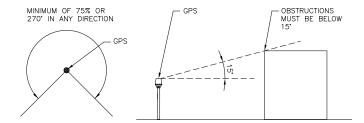

GPS MINIMUM SKY VIEW REQUIREMENTS










С	PROJECT NO:	172862
	DRAWN BY:	SAF
	CHECKED BY:	SEW

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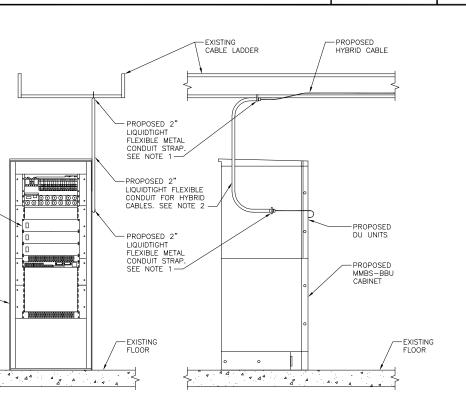
MS72XC330-A F1/MN0330-WITHROP 19900 MANNING TRAIL N STILLWATER, MN 55082

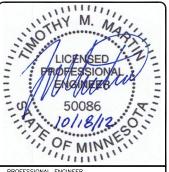SHEET TITLE

**EQUIPMENT DETALS** 

SHEET NUMBER

A-7




SIDE VIEW

DU UNITS

MMBS-BBU CABINET

PROPOSED LIQUIDTIGHT FLEXIBLE METAL CONDUIT FROM CABLE LADDER TO CABINET SUPPORT SHALL BE STRAPPED AT TOP AND BOTTOM AT INTERVALS NOT

FRONT VIEW

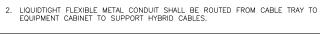


HYBRID AND TELCO LINE SUPPORT DETAIL





D

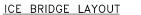


NO SCALE

2'-0"

NO SCALE

Ε

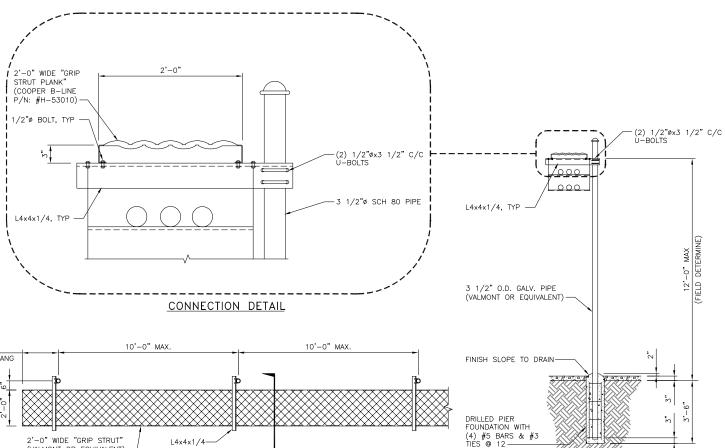


2'-0" MAX OVERHANG 2'-0" WIDE "GRIP STRUT" 14x4x1/4 (VALMONT OR EQUIVALENT) -

NO SCALE

В


<u>PLAN</u>

SECTION 1

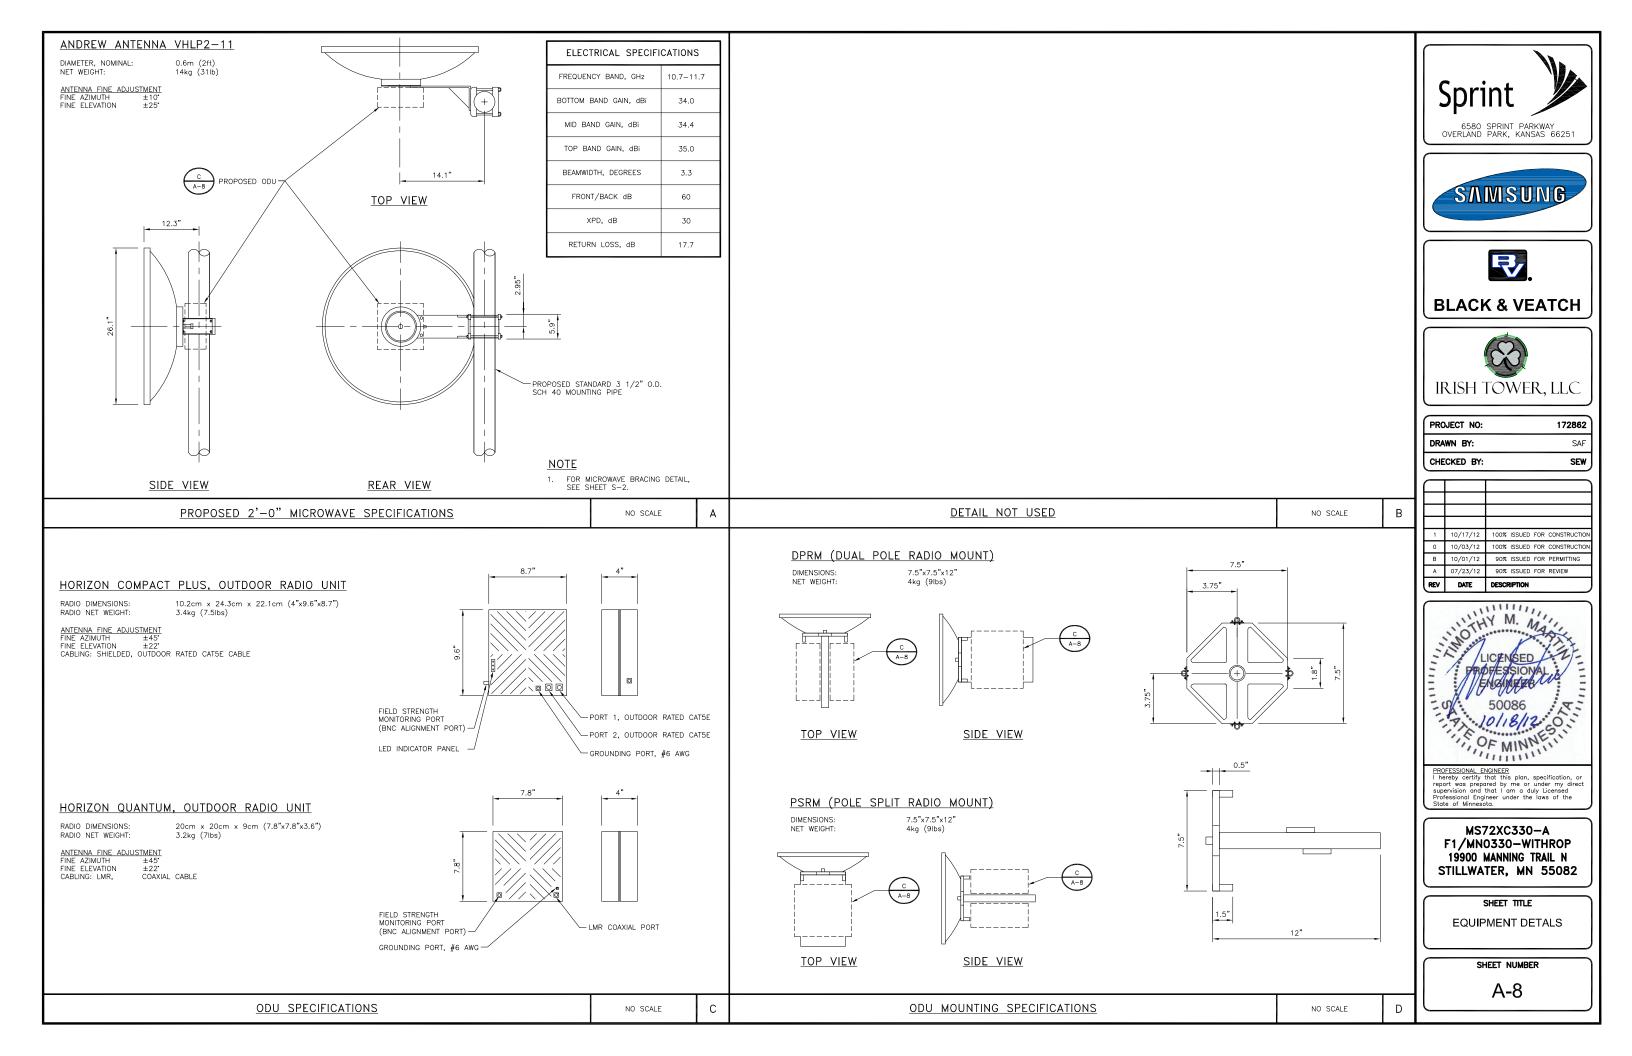


MICROWAVE CABLE CHART							
CABLE TYPE (TIMES MICROWAVE)	OUTER DIAMETER	DUAL MODEM, SINGLE IF (20dB) (WITH COMBINER)	DUAL MODEM, DUAL IF (24dB) (NO COMBINER)				
LMR-400	3/8"	301'	367'				
LMR-600	9/16"	462'	564'				
LMR-900	7/8"	683'	835'				

	MICROWAVE COLOR CODE CHART								
DISH	PATH	RADIO		PA	TH	RADIO			
NUMBER	NUMBER	NUMBER	STRIPE 7 MSB	STRIPE 6	STRIPE 5	STRIPE 4	STRIPE 3	STRIPE 2	STRIPE 1 LSB
1	MS72XC286		PURPLE	PURPLE	PURPLE	PURPLE	PURPLE	PURPLE	PURPLE

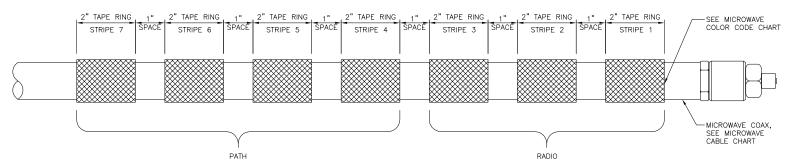

# MICROWAVE COAX CONNECTION AT MICROWAVE

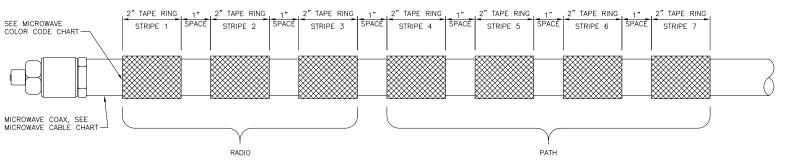

MICROWAVE COAX CONNECTION AT MMBS CABINET

- ALL CABLES SHALL BE MARKED AT THE TOP AND BOTTOM WITH 2" COLORED TAPE OR STENCIL TAG. COLOR TAPE SHALL BE OBTAINED FROM GRAYBAR ELECTRIC.
- 2. THE FIRST RING SHALL BE CLOSEST TO THE END OF THE CABLE AND SPACED APPROXIMATELY 2" FROM AN END CONNECTOR, WEATHERPROOFING, OR BREAK-OUT CYLINDER, WITH 1" SPACE BETWEEN EACH RING.
- 3. THE 2" COLORED TAPE(S) SHALL EACH BE WRAPPED A MINIMUM OF 3 TIMES AROUND THE CABLE AND THE TAPE SHALL BE KEPT IN THE SAME LOCATION AS MUCH AS POSSIBLE.

NO SCALE Α

PROJECT NO:

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0 10/03/12 100% ISSUED FOR CONSTRUCTION B 10/01/12 90% ISSUED FOR PERMITTING A 07/23/12 90% ISSUED FOR REVIEW

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IRISH TOWER, LLC

172862

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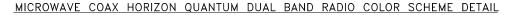
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SHEET TITLE

**EQUIPMENT DETALS** 

SHEET NUMBER

A-9



DETAIL NOT USED


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FREQUENCY COLO		
FREQUENCY COLOR CODE	FIRST RING	SECOND RING
800 MHz	YELLOW	GREEN
1900 MHz	YELLOW	RED
1900 MHz	YELLOW	BROWN

TYPICAL	HYBRID C	ABLE 1 COI	LOR CODE
SECTOR	FIRST RING	SECOND RING	THIRD RING
1	GREEN	NO TAPE	NO TAPE
2	GREEN	GREEN	NO TAPE
3	GREEN	GREEN	GREEN

TYPICAL	HYBRID C	ABLE 2 COI	OR CODE		
SECTOR	FIRST RING	SECOND RING	THIRD RING		
1	BLUE	NO TAPE	NO TAPE		
2	BLUE	BLUE	NO TAPE		
3	BLUE	BLUE			

1									
	TYPICAL JUMPER CABLE COLOR CODE								
FREQUENCY	ANTENNA PORT	RRU PORT	SECTOR 1	SECTOR 2	SECTOR 3	SECTOR 4			
	RET	RET	PURPLE	PURPLE/PURPLE	PURPLE/PURPLE/PURPLE	PURPLE/PURPLE/PURPLE			
800 MHz	800 MHz +45*	ANT 1	WHITE	WHITE/WHITE	WHITE/WHITE/WHITE	WHITE/WHITE/WHITE			
	800 MHz -45*	ANT 0	BLUE	BLUE/BLUE	BLUE/BLUE/BLUE	BLUE/BLUE/BLUE/BLUE			
	PCS1 -45*	ANT 0	BLUE	BLUE/BLUE	BLUE/BLUE/BLUE	BLUE/BLUE/BLUE/BLUE			
	PCS1 +45°	ANT 1	WHITE	WHITE/WHITE	WHITE/WHITE/WHITE	WHITE/WHITE/WHITE/WHITE			
1900 MHz	PCS2 -45*	ANT 2	GREEN	GREEN/GREEN	GREEN/GREEN/GREEN	GREEN/GREEN/GREEN			
	PCS2 +45°	ANT 3	BROWN	BROWN/BROWN	BROWN/BROWN/BROWN	BROWN/BROWN/BROWN			
	RET	RET	ORANGE	ORANGE/ORANGE	ORANGE/ORANGE	ORANGE/ORANGE/ORANGE			

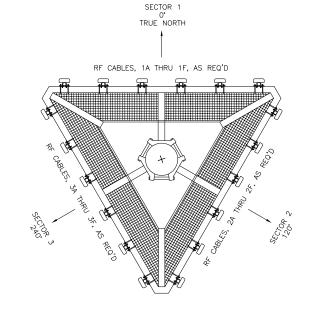

TOP VIEW

HYBRID AND JUMPER CABLES COLOR CODING NO SCALE

ANTENNA SECTOR AND CABLE COLOR DEFINITION DETAIL

NO SCALE


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-(4) PAIR

TO CABINET

-(6) FIBER CABLES


2" TAPE RING 1" SPACE 2" TAPE RING (4) PAIR COPPER -BETWEEN HYBRID CABLE CODE AND FREQUENCY COLOR SECOND RING FREQUENCY COLOR CODE FIRST RING BETWEEN RINGS SECOND RING BETWEEN THIRD RING FIRST RING FROM END OF BREAK-OUT CYLINDER FIRST RING BETWEEN SECOND RING BETWEEN THIRD RING FREQUENCY COLOR CODE HYBRID COLOR CODE (IF APPLICABLE PER (IF APPLICABLE PER (IF APPLICABLE PER (IF APPLICABLE PER SECTOR) SECTOR) SECTOR) SECTOR) CODE TO ANTENNA FREQUENCY COLOR CODE (SEE DETAIL A FOR TABLE) (6) FIBER HYBRID CABLE TO CABINET — CÁBLES -HYBRID COLOR CODE TAPE HYBRID COLOR CODE TAPE NO SPACE BETWEEN TAPE HYBRID CABLE COLOR TAPE HYBRID CABLE COLOR TAPE WRAP TAPE AROUND CABLE, (SEE DETAIL A FOR TABLE) (SEE DETAIL A FOR TABLE)-(SEE DETAIL A FOR TABLE)— THREE TIMES, MIN. (TYP) -

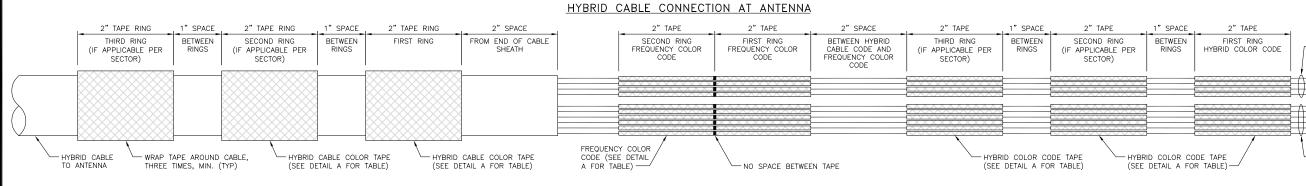

# <u>NOTES</u>

- ALL CABLES SHALL BE MARKED AT THE TOP AND BOTTOM WITH 2" COLORED TAPE OR STENCIL TAG. COLOR TAPE SHALL BE OBTAINED FROM GRAYBAR ELECTRIC.
- 2. THE FIRST RING SHALL BE CLOSEST TO THE END OF THE CABLE AND SPACED APPROXIMATELY 2" FROM AN END CONNECTOR, WEATHERPROOFING, OR BREAK-OUT CYLINDER, WITH 1" SPACE BETWEEN EACH RING.
- 3. THE HYBRID CABLE COLOR SHALL BE APPLIED IN ACCORDANCE WITH THE "TYPICAL HYBRID CABLE COLOR CODE" TABLE ABOVE
- 4. INDIVIDUAL POWER PAIRS AND FIBER CABLES SHALL BE LABELED WITH BOTH THE HYBRID CABLE COLOR FOR THE RESPECTIVE SECTOR AND A FREQUENCY COLOR CODE IN ACCORDANCE WITH THE "FREQUENCY COLOR CODE FOR PAIRS AND FIBER CABLES OF HYBRID CABLE" TABLE ABOVE.
- 5. A 2" GAP SHALL SEPARATE THE HYBRID CABLE COLOR CODE FROM THE FREQUENCY COLOR CODE.
- 6. THE 2" COLOR RINGS FOR THE FREQUENCY CODE SHALL BE PLACED NEXT TO EACH OTHER WITH NO SPACES.
- THE 2" COLORED TAPE(S) SHALL EACH BE WRAPPED A MINIMUM OF 3 TIMES AROUND THE HYBRID CABLE OR INDIVIDUAL CABLES, AND THE TAPE SHALL BE KEPT IN THE SAME LOCATION AS MUCH AS POSSIBLE.
- 8. COLOR BAND ON JUMPERS SHALL BE 1" WIDE WITH A 1" SPACE.

# HYBRID CABLE CONNECTION AT CABINET

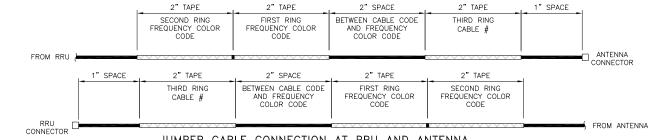

JUMPER CABLE CONNECTION AT RRU AND ANTENNA

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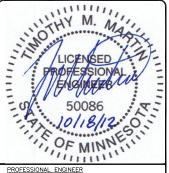






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SHEET TITLE

ANTENNA & CABLE COLOR **CODING DETAILS** 


SHEET NUMBER

RF-1

HYBRID CABLE COLOR SCHEME DETAIL

NO SCALE

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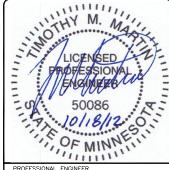

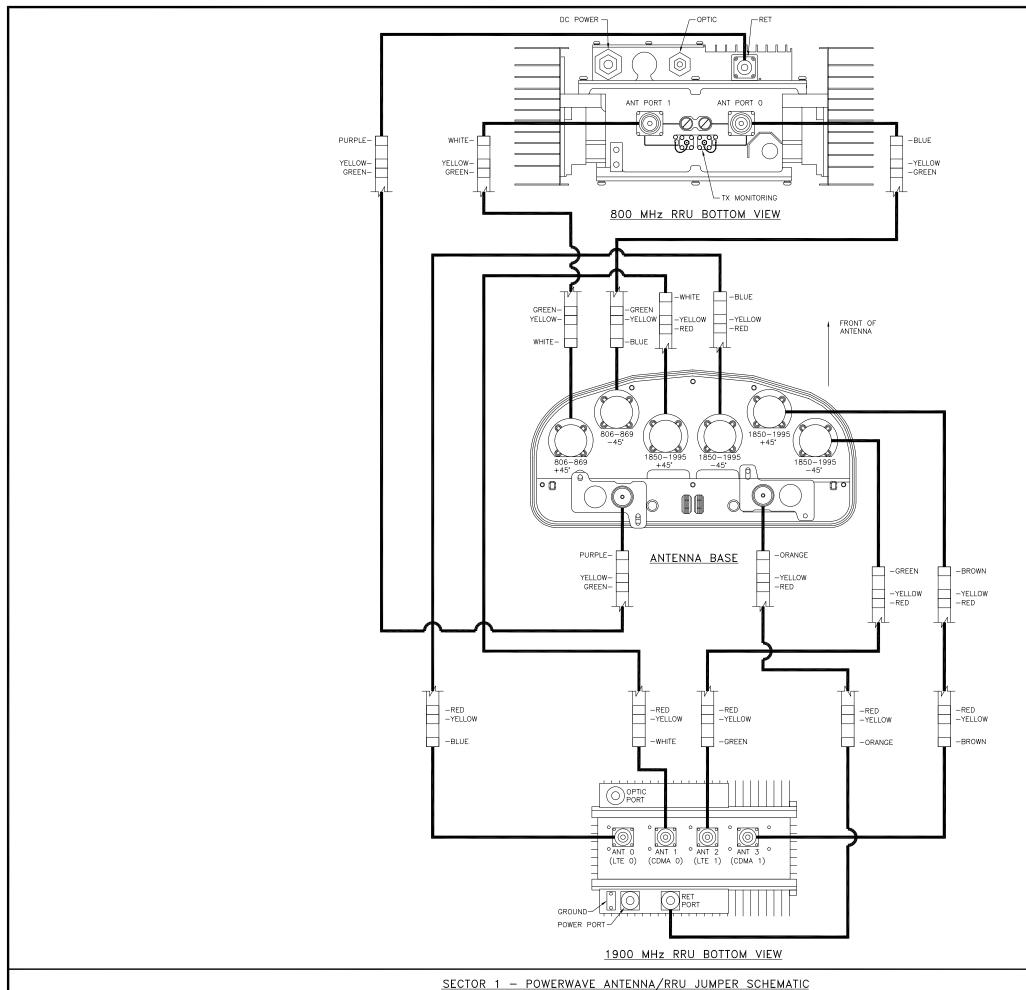
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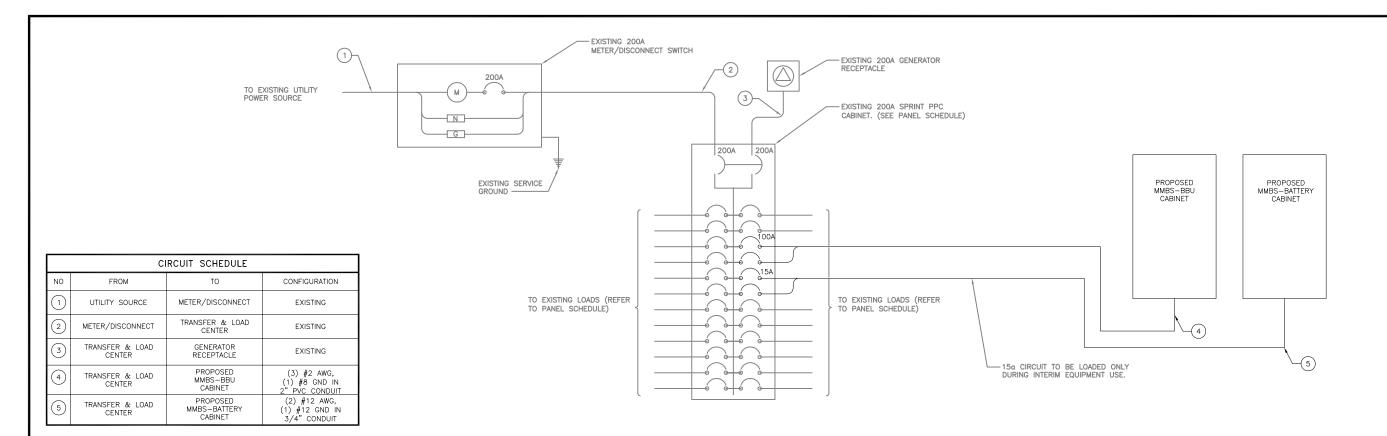
MS72XC330-A F1/MN0330-WITHROP 19900 MANNING TRAIL N STILLWATER, MN 55082

SHEET TITLE

ANTENNA/RRU JUMPER SCHEMATIC

SHEET NUMBER

RF-2



ELECTRICAL ONE-LINE DIAGRAM

NO SCALE

Α

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PROJECT NO

SAF CHECKED BY: SEW

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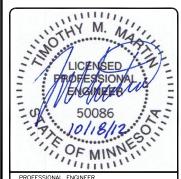
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IRISH TOWER, LLC

172862

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SHEET TITLE

SINGLE LINE DIAGRAM & POWER PANEL SCHEDULE

SHEET NUMBER

E-1


# **ELECTRICAL NOTES**

- 1. ALL ELECTRICAL WORK SHALL BE DONE IN ACCORDANCE WITH CURRENT NATIONAL ELECTRICAL CODES AND ALL LOCAL AND STATE CODE, LAWS, AND ORDINANCES. PROVIDE ALL COMPONENTS AND WIRING SIZES AS REQUIRED TO MEET NEC STANDARDS
- 2. CONTRACTOR SHALL COORDINATE WITH LOCAL POWER COMPANY FOR REQUIREMENTS OF POWER SERVICE LINE TO THE METER BASE, POWER SERVICE REQUIREMENT IS COMMERCIAL AC NOMINAL 120/208 VOLT OR 120/240 VOLT, SINGLE PHASE WITH 200 AMP RATING.
- 3. CONTRACTOR SHALL COORDINATE WITH LOCAL TELEPHONE COMPANY FOR REQUIREMENTS OF "T1" SERVICE LINE TO TERMINATE AT THE PPC CABINET.
- 4. UNDERGROUND POWER AND TELCO SERVICE LINES SHALL BE ROUTED IN A COMMON TRENCH. ALL UNDERGROUND CONDUIT SHALL BE PVC SCHEDULE 40 AND CONDUIT EXPOSED ABOVE GROUND SHALL BE RIGID GALVANIZED STEEL UNLESS OTHERWISE INDICATED.
- 5. ALL TELCO CONDUIT LINES SHALL BE 4" SCH. 40 PVC CONDUIT UNLESS OTHERWISE INDICATED. THE TELCO CONDUIT FROM THE PPC SHALL BE ROUTED AND TERMINATED AT DESIGNATED TELCO DEMARCATION OR 2-FEET OUTSIDE FENCED AREA, NEAR UTILITY POLE (IN FENCED AREA), OR END CAP OFF AND PROVIDE MARKER STAKE PAINTED BRIGHT ORANGE WITH DESIGNATION FOR TELCO SERVICE.
- 6. CONDUITS INSTALLED AT PCS EQUIPMENT ENDS PRIOR TO THE EQUIPMENT INSTALLATION SHALL BE STUBBED AND CAPPED AT 6" ABOVE GRADE OR PLATFORM. IF SERVICE LINES CAN'T BE INSTALLED INITIALLY, PROVIDE NYLON PULL CORD IN CONDUITS.
- 7. THE SPRINT CABINET, INCLUDING 200 AMP LOAD PANEL AND TELCO PANEL, SHALL BE PROVIDED BY OWNER AND INSTALLED BY THE CONTRACTOR. CONTRACTOR IS TO INSTALL BREAKER(S) NOT PROVIDED BY MANUFACTURER. SEE PANEL SCHEDULE ON THIS SHEET FOR BREAKER REQUIREMENTS.
- 8. LOCATION OF ELECTRIC METER AND DISCONNECT SWITCH TO BE COORDINATED BY ELECTRICAL CONTRACTOR AND FIELD CONSTRUCTION MANAGER.
- 9. #2 WIRE TO BE UTILIZED IN ELECTRIC SERVICE RUNS EXCEEDING 100'.
- 10. CONTRACTOR SHALL INSPECT THE EXISTING CONDITIONS PRIOR TO SUBMITTING BID. ANY QUESTIONS ARISING DURING THE BID PERIOD IN REGARDS TO THE CONTRACTORS FUNCTIONS, THE SCOPE OF WORK, OR ANY OTHER ISSUE RELATED TO THIS PROJECT SHALL BE BROUGHT UP DURING THE BID PERIOD WITH THE PROJECT MANAGER FOR CLARIFICATION, NOT AFTER THE CONTRACT HAS BEEN AWARDED.
- 11. LOCATION OF FOUIPMENT, CONDUIT AND DEVICES SHOWN ON THE DRAWINGS ARE APPROXIMATE AND SHALL BE COORDINATED WITH FIELD CONDITIONS

MAN BREAKER: 200 AMP SUFFACE S									TBD	JMBER:	MODEL N			0	MS72XC33	SER:	TE NUM	
MOUNT: SUPFACE NEMA R N				3			WIRE:		1		PHASE:				240V/120	VOLTAGE:		
NALOSURE TYPE:   NEMA 3R   EXISTING   NI GROUND BORNET ED   NTERNAL TYSS: TED   NTERNA				TBD			AIC:		200 AMPS	ING:	BUSS RAT				200 AMP	AKER:	MAIN BREAKER:	
PARLE STATUS: EXISTING   NTERNAL TYSS: TDD   N				TBD		BAR:	GROUND E		YES	BAR:	NEUTRAL				SURFACE		DUNT:	
BREAKER   BREAKER   BREAKER   AMPS   POLES   STATUS   LOAD VA   FACTOR   VA   VA   VA   FACTOR   LOAD VA   STATUS   POLES   BREAKER									TBD	JND BOND	N to GRO				NEMA 3R	RE TYPE:	ICLOSU	
CKT   LOAD DESCRIPTION   AMPS   POLES   STATUS   DUES   AMPS   DUES   STATUS   DUES   AMPS   DUES   AMPS   DUES   STATUS   DUES   AMPS   LOAD VA   FACTOR   LOAD VA   STATUS   POLES   AMPS   LOAD VA   FACTOR   LOAD VA   STATUS   POLES   AMPS   LOAD VA   FACTOR   LOAD VA   STATUS   POLES   AMPS   LOAD DESCRIPTION									TBD	TVSS:	INTERNAL				EXISTING	ATUS:	NEL ST	
3   90   ON   7000   1.25   8780   1.00   0 ON     30   5   RET #3   30   2 ON   0   0.00   400   0.10   400   ON     30   RET #4   7   7   30   ON   0   0.00   400   0.10   400   ON     30   RET #4   7   7   7   7   7   7   7   7   7		PTION	LOAD DESCRIPTION										R	BREAKER		OAD DESCRIPTION	скт	
SET # # # # # # # # # # # # # # # # # # #			RET #2	30	2	ON	0	1.00		8750	1.25	7000	ON	2	30	RET #1	1	
7   No. 10		-	1	30	-	ON	0	1.00	8750		1.25	7000	ON	_	30		3	
9 RET #5 90 2 CM 990 1.00 1140 1.00 180 ON 2 30 RET #6 111			RET #4	30	2	ON	400	1.00		400	0.00	0	ON	2	30	RET #3	5	
11     30			1	30	-	ON	400	1.00	400		0.00	0	ON	_	30		7	
13   RET #7   30   2   ON   77000   1.25   8750   1.00   0   ON   2   30   RET #8			RET #6	30	2	ON	180	1.00		1140	1.00	960	ON	2	30	RET #5	9	
15				30	1	ON	500	1.00	700		1.00	200	ON	-	30		11	
17   CDMA   30   2   ON   0   0.00   400   1.00   400   ON   2   30   CDMA     19   30			RET #8	30	2	ON	0	1.00		8750		7000	ON	2	30	RET #7	13	
19				30	-	ON	0	1.00	8750		1.25	7000	ON	-	30		15	
21 HVAC #1   60   2   ON   980   1.00   1140   1.00   180   ON   2   35   HVAC #2			CDMA	30	2	ON	400	1.00		400	0.00	0	ON	2	30	CDMA	17	
22   00   00   00   00   00   00   00				30	-	ON	400	1.00	400		0.00	0	ON	-	30			
25 HVAC #3 35 2 ON 980 1.00 1140 1.00 180 ON 2 60 SURGE ARRESTOR 27 0N 250 1.00 1.00 500 ON - 60 UN - 1 20 UN - 1 20 UN - 60 UN - 20 UN - 60 UN - 20 UN - 1 20 UN - 1 20 UN - 60 UN - 20 UN - 1 20 UN - 1 20 UN - 60 UN - 20 UN - 1 20 UN - 60 UN - 20 UN - 1 20 UN - 1 20 UN - 60 UN - 20 UN - 1 20 UN - 60 UN - 20 UN - 20 UN - 20 UN - 1 20 UN - 60 UN - 20 UN			HVAC #2		2					1140	1.00			2		HVAC#1		
27			<u> </u>						700						_			
29 GENERATOR 20 2 ON 0 0.00 400 1.00 400 ON 1 20 LIGHTING 31 20 ON 0 0.00 400 1.00 400 ON 1 20 SIGNITISETECTOR 33 RECEPTACLE 20 1 ON 960 1.00 7860 1.00 7000 ON 2 100 SANSIVING MINBU 35 RECEPTACLE 20 1 ON 200 1.00 7200 ON 100 37 RECEPTACLE 20 1 ON 200 1.00 7000 ON 100 38 RECEPTACLE 20 1 ON 200 1.00 1140 1.00 180 ON 2 15 SANSIVING MINBU 39 RECEPTACLE 20 ON 200 1.00 1700 1.00 500 ON 20 RECEPTACLE		TOR	SURGE ARRESTOR	-	2					1140				_		HVAC#3		
31 RECEPTACLE 20 1 ON 990 1.00 7800 1.00 400 ON 1 20 SAMSUNG MIBU ( 35 RECEPTACLE 20 1 ON 990 1.00 7800 1.00 7000 ON 2 100 SAMSUNG MIBU ( 35 RECEPTACLE 20 1 ON 200 1.00 7200 1.00 7000 ON - 100 37 RECEPTACLE 20 2 ON 990 1.00 1140 1.00 180 ON 2 15 SAMSUNG MIBU ( 38 RECEPTACLE 20 - ON 200 1.00 1140 1.00 180 ON 2 15 SAMSUNG BATT F, 39 RECEPTACLE 20 - ON 200 1.00 700 ON - 20 RECEPTACLE									700									
33 RECEPTACLE 20 1 ON 960 1.00 7860 1.00 7000 ON 2 100 SAMSUNG MMBU ( 35 RECEPTACLE 20 1 ON 200 1.00 7200 1.00 7000 ON 100 37 RECEPTACLE 20 2 ON 960 1.00 1140 1.00 180 ON 2 15 38 RECEPTACLE 20 ON 200 1.00 140 500 ON 20 RECEPTACLE 39 RECEPTACLE 20 ON 200 1.00 700 1.00 500 ON 20 RECEPTACLE					_					400		_		_		GENERATOR		
35 RECEPTACLE 20 1 ON 200 1.00 7200 1.00 7000 ON 100 100 100 ON 200 ON 100 ON 200 ON 20									400			_						
37 RECEPTACLE 20 2 ON 960 1.00 1140 1.00 180 ON 2 15 SAMSUNG BATT F. 39 RECEPTACLE 20 ON 200 1.00 700 1.00 500 ON 20 RECEPTACLE	NET	IBU CABINET	SAMSUNG MMBU CABINET							7960				-				
39 RECEPTACLE 20 ON 200 1.00 700 1.00 500 ON 20 RECEPTACLE	_								7200									
	_	TT FAN								1140				_				
19290 9850 VA TOTALKVA 20.14			RECEPTACLE	20	-	ON	500	1.00	700		1.00	200	ON		20	RECEPTACLE	39	
I 102901 98501 VA I ITOTAL KVA I 20.14																		
POST-MIGRATION PERIOD LOADING AMPS 83.92	_							VA	9850	10290								

# ELECTRICAL NOTES (CON'T)

- 12. THE CONDUIT RUNS AS SHOWN ON THE PLANS ARE APPROXIMATE. EXACT LOCATION AND ROUTING SHALL BE PER EXISTING FIELD CONDITIONS.
- 13. PROVIDE PULL BOXES AND JUNCTION BOXES WHERE SHOWN OR REQUIRED BY NEC.
- 14. ALL CONDUITS SHALL BE MET WITH BENDS MADE IN ACCORDANCE WITH NEC TABLE 346-10. NO RIGHT ANGLE DEVICE OTHER THAN STANDARD CONDUIT ELBOWS WITH 12" MINIMUM INSIDE SWEEPS FOR ALL CONDUITS 2" OR LARGER.
- 15. ALL CONDUIT TERMINATIONS SHALL BE PROVIDED WITH PLASTIC THROAT INSULATING GROUNDING BUSHINGS.
- 16. ALL WIRE SHALL BE TYPE THWN, SOLID, ANNEALED COPPER UP TO SIZE #10 AWG (#8 AND LARGER SHALL BE CONCENTRIC STRANDED) 75 DEGREE C, (167 DEGREES F), 98% CONDUCTIVITY, MINIMUM #12.
- 17. ALL WIRES SHALL BE TAGGED AT ALL PULL BOXES, J-BOXES, EQUIPMENT BOXES AND CABINETS WITH APPROVED PLASTIC TAGS, ACTION CRAFT, BRADY, OR
- 18. ALL NEW MATERIAL SHALL HAVE A U.L. LABEL.
- 19. CONDUIT ROUGH-IN SHALL BE COORDINATED WITH THE MECHANICAL EQUIPMENT TO AVOID LOCATION TO CONFLICTS. VERIFY WITH MECHANICAL CONTRACTOR AND COMPLY AS REQUIRED.
- 20. ALL PANEL DIRECTORIES SHALL BE TYPEWRITTEN NOT HAND WRITTEN.
- 21. INSTALL AN EQUIPMENT GROUNDING CONDUCTOR IN ALL CONDUITS PER THE SPECIFICATIONS AND NEC. THE EQUIPMENT GROUNDING CONDUCTORS SHALL BE BONDED AT ALL JUNCTION BOXES, PULL BOXES, AND ALL DISCONNECT SWITCHES, STARTERS, AND EQUIPMENT CABINETS.
- 22. THE CONTRACTOR SHALL PREPARE AS—BUILT DRAWINGS, DOCUMENT ANY AND ALL WIRING AND EQUIPMENT CONDITIONS AND CHANGES WHILE COMPLETING THIS CONTRACT. SUBMIT AT SUBSTANTIAL COMPLETION.
- 23. ALL DISCONNECT SWITCHES AND OTHER CONTROLLING DEVICES SHALL BE PROVIDED WITH ENGRAVED PHENOLIC NAMEPLATES INDICATING EQUIPMENT CONTROLLED, BRANCH CIRCUITS INSTALLED ON, AND PANEL FIELD LOCATIONS FED FROM (NO EXCEPTIONS.)
- 24. ALL ELECTRICAL DEVICES AND INSTALLATIONS OF THE DEVICES SHALL COMPLY WITH (ADA) AMERICANS WITH DISABILITIES ACT AS ADOPTED BY THE APPLICABLE
- 25. PROVIDE CORE DRILLING AS NECESSARY FOR PENETRATIONS OR RISERS THROUGH BUILDING. DO NOT PENETRATE STRUCTURAL MEMBERS WITHOUT CONSTRUCTION MANAGERS APPROVAL. SLEEVES AND/OR PENETRATIONS IN FIRE RATED CONSTRUCTION SHALL BE PACKED WITH FIRE RATED MATERIAL WHICH SHALL MAINTAIN THE FIRE RATING OF THE WALL OR STRUCTURE. FILL FOR FLOOR PENETRATIONS SHALL PREVENT PASSAGE OF WATER, SMOKE, FIRE AND FUMES. ALL MATERIAL SHALL BE UL APPROVED FOR THIS PURPOSE.
- 26. ELECTRICAL CHARACTERISTICS OF ALL EQUIPMENT (NEW AND EXISTING) SHALL BE FIELD VERIFIED WITH THE OWNER'S REPRESENTATIVE AND EQUIPMENT SUPPLIER PRIOR TO ROUGH-IN OF CONDUIT AND WIRE. ALL EQUIPMENT SHALL BE PROPERLY CONNECTED ACCORDING TO THE NAMEPLATE DATA FURNISHED ON THE EQUIPMENT (THE DESIGN OF THESE PLANS ARE BASED UPON BEST AVAILABLE INFORMATION AT THE TIME OF DESIGN AND SOME EQUIPMENT CHARACTERISTICS MAY VARY FROM DESIGN AS SHOWN ON THESE DRAWINGS).
- 27. LOCATION OF ALL OUTLET, BOXES, ETC., AND THE TYPE OF CONNECTION (PLUG OR DIRECT) SHALL BE CONFIRMED WITH THE OWNER'S REPRESENTATIVE PRIOR TO
- 28. SPLIT BREAKERS SHALL BE USED ON 120V LOADS IN THE EVENT THAT ADDITIONAL CIRCUIT SPACE IS REQUIRED FOR PROPOSED EQUIPMENT.
- 29. PANEL SCHEDULE LOADING AND CIRCUIT ARRANGEMENT ON E-1 REFLECTS MIGRATION PERIOD CIRCUMSTANCES. REFER TO E-4 FOR POST-MIGRATION PANEL SCHEDULE LOADING AND CIRCUIT ARRANGEMENT IN WHICH EXISTING LEGACY EQUIPMENT HAS BEEN REMOVED.

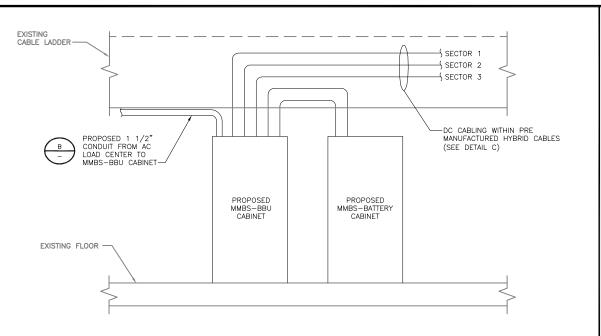

# DC POWER ELECTRICAL NOTES

- 1. MINIMUM CABLE LENGTH BETWEEN THE DU AND BATTERY IS 70MM (2.75 in).
- 2. MAXIMUM CABLE LENGTH DISTANCE IS 900mm (35.43" in).
- 3. ROUTE DC CONDUCTORS IN CONDUITS TO PROPOSED MMBS—BBU CABINET 48VDC POWER DISTRIBUTION PANEL TO AND FROM PROPOSED MMBS—BATTERY CABINET.
- 4. -48 VDC CABLES BETWEEN PROPOSED MMBS-BBU CABINET & RRU'S ARE FACTORY ASSEMBLED AND EQUIPPED WITH ONE PRE-TERMINATED END.
- 5. ALL FIELD INSTALLED DC CABLING SHALL BE TYPE RHH/RHW AND SHALL BE UL THERMOSET INSULATED.

>	EXISTING CABLE LADDER
1 1/2" NON-METALLIC SEAL TIGHT FLEXIBLE CONDUIT FROM STUB TO EQUIPMENT (6'-0" MAX)	1 1/2" HEAVY WALL STRAIGHT CONNECTOR STAND-OFF CLAMP STRAIGHT CONNECTOR STAND-OFF CLAMP STAND-OFF CLAMP STAND-OFF CLAMP STAND-OFF CLAMP FROM AC LOAD CENTER
SEAL TIGHT CONNECTION (SEE DETAIL D ON THIS SHEET)	
	PROPOSED MMBS—BBU CABINET

DC POWER DIAGRAM

NO SCALE


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EQUIPMENT POWER CONDUIT CONNECTIONS

NO SCALE

B

	TYPE 1	TYPE 2	TYPE 3	TYPE 4	TYPE 5					
TOTAL LENGTH	$\sim$ 40m ( $\sim$ 152')	$\sim$ 60m ( $\sim$ 197')	~ 75m (~246')	$\sim$ 90m ( $\sim$ 295')	~110m (~ 361')					
HYBRID POWER CABLE CONFIGURATION	AWG 10, 1 PAIR AWG 12, 3 PAIR	AWG 8, 1 PAIR AWG 10, 3 PAIR	AWG 6, 1 PAIR AWG 8, 1 PAIR AWG 10, 2 PAIR	AWG 6, 1 PAIR AWG 8, 3 PAIR	AWG 4, 1 PAIR AWG 6, 3 PAIR					
CABLE DIAMETER	25mm (0.98")	27mm (1.06")	30mm (1.18")	30/32mm (1.26")	32mm (1.26")					
BENDING RADIUS	300mm (11.81")	330mm (12.99")	390mm (15.35")	450mm (17.72")	450mm (17.72")					
OPTIC CABLE			LC/PC-TO-LC/PC, SINGLE MC	DDE						
MMBS-BBU CABINET (POWER CABLE TERMINAL MAX SIZE AWG 4)		2 PAIR	POWER AND OPTIC CABLE WIT	H PE PIPE						
RRU POWER CABLE SPEC	AWG 8, 15.7mm (0.62") AWG 10, 12.2mm (0.48")									
NON USE POWER AND OPTIC CABLE PROTECTION	2 PAIR POWER AND OPTIC CABLE WITH PE PIPE	2 PAIR POWER AND OPTIC CABLE WITH PE PIPE	2 PAIR POWER AND OPTIC CABLE WITH PE PIPE	2 PAIR POWER AND OPTIC CABLE WITH PE PIPE						



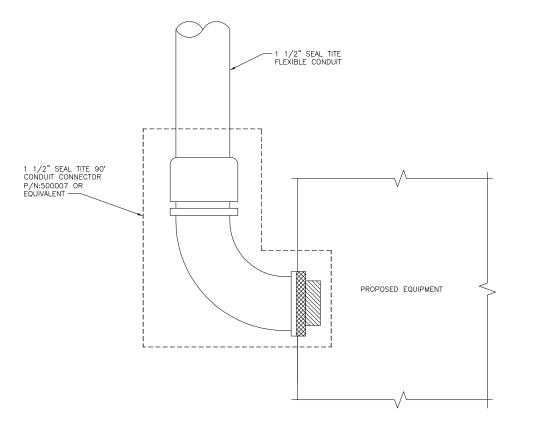








PROJECT NO:	172862
DRAWN BY:	SAF
CHECKED BY:	SEW

ı	REV	DATE	DESCRIPTION
ı	Α	07/23/12	90% ISSUED FOR REVIEW
	В	10/01/12	90% ISSUED FOR PERMITTING
1	0	10/03/12	100% ISSUED FOR CONSTRUCTION
ı	1	10/17/12	100% ISSUED FOR CONSTRUCTION
ı			
ı			
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ı			)

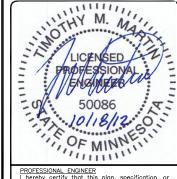

PROFESSIONAL ENGINEER
I hereby certify that this plan, specification, or report was prepored by me or under my direct supervision and that I am a duly Licensed Professional Engineer under the laws of the State of Minnesota.

MS72XC330-A F1/MN0330-WITHROP 19900 MANNING TRAIL N STILLWATER, MN 55082

SHEET TITLE

DC POWER ONE-LINE & DETAILS

SHEET NUMBER

E-2


HYBRID CABLE TYPE


NO SCALE

С

SEAL TITE POWER CONDUIT CONNECTION TO PROPOSED EQUIPMENT DETAIL

NO SCALE

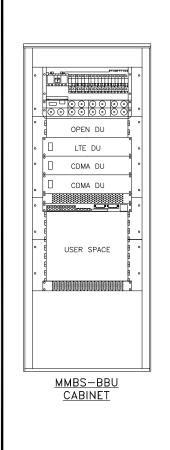

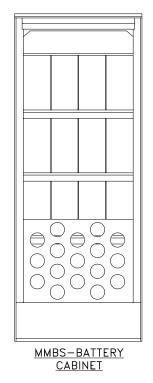

DETAIL NOT USED

ITEM	SPECIFICATION
OPERATING TEMPERATURE	0 ~ 40°C (NANUTAL CONVECTION)
RATINGS	SEISMIC ZONE 4 FCC PART 15 CLASS A
AC POWER	SINGLE PHASE 208~240 VAC
DC POWER	14 KW ⊚ −48 VAC (7 RECTIFIERS, 96% EFFICIENCY)
CABINET SIZE (W x D x H)	600mm x 600mm x 2,000mm 23.62" x 23.62" x 78.74" FRONT DOOR W/O SENSOR
CABINET WEIGHT	POWER CABINET: T.B.D. W/O EQUIPMENT BATTERY CABINET: T.B.D. W/O EQUIPMENT
CABINET USER SPACE	8 RU FOR BS DU 8 RU FOR AUX 2 RU FOR RESERVED 8 RU FOR BATTERY 1 STRING (FOR SINGLE)
BATTERY CABINET	4* 8U SEISMIC BATTERY SHELF     4 x BATTERY BREAKERS AND MONITORS








**BLACK & VEATCH** 



-	PROJECT NO:	172862
	DRAWN BY:	SAF
	CHECKED BY:	SEW

0 10/03/12 100% ISSUED FOR CONSTRUCTION B 10/01/12 90% ISSUED FOR PERMITTING A 07/23/12 90% ISSUED FOR REVIEW REV DATE DESCRIPTION

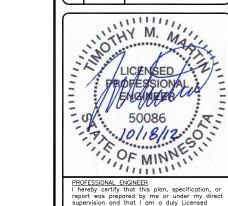

PROFESSIONAL ENGINEER
I hereby certify that this plan, specification, or report was prepored by me or under my direct supervision and that I am a duly Licensed Professional Engineer under the laws of the State of Minnesota.

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SHEET TITLE


POWER & TELCO DETAILS

SHEET NUMBER

E-3

D

NO SCALE

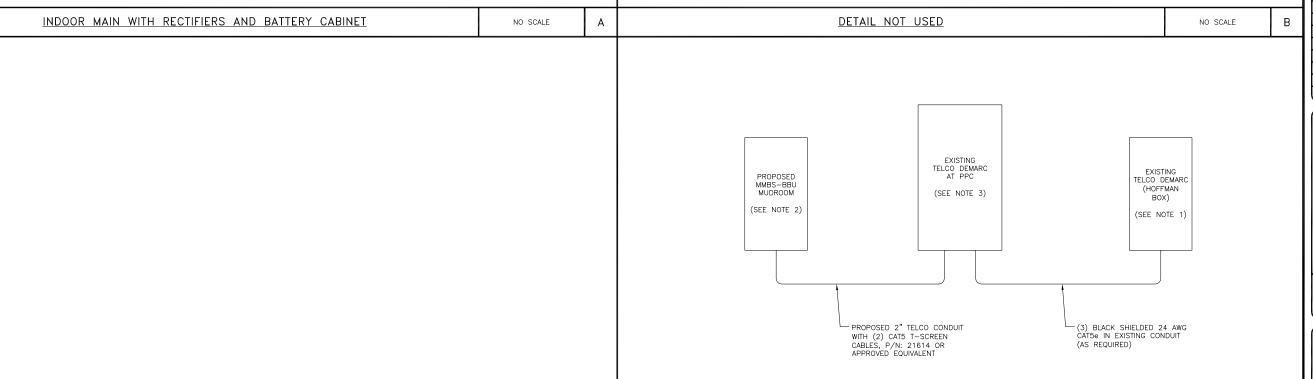

С

NO SCALE

1. CONTRACTOR TO INSTALL NEW 66 BLOCK IN EXISTING HOFFMAN BOX AT SITES MAIN TELCO DEMARC. 2. CONTRACTOR SHALL INSTALL RJ-45 ENDS ON ALL RUNS OF CAT5e INTO MMBS-BBU MUDROOM.

3. CONTRACTOR TO INSTALL NEW 66 BLOCK IN EXISTING TELCO BOX NEXT TO EXISTING PPC CABINET.

TELCO RISER DETAIL

SITE NUM	IRED.	MS72XC33	20			MODEL N	IIMBED:	TBD							
VOLTAGE			240V/120			PHASE:	OWIDEN.	1		WIRE:			3		
MAIN BREAKER: MOUNT:		200 AMP				BUSS RA	TING	200 AMPS		AIC:			TBD		
		SURFACE				NEUTRAL		YES		GROUND	DAD.		TBD		
		NEMA 3R					. DAN: UND BONE			GHOUND	D BAR:		עפו		
PANEL S		EXISTING													
PANEL 5	I I I I I I I I I I I I I I I I I I I	EXISTING		BREAKE		INTERNA	L 1V55:	TBD							
СКТ	LOAD DESCRIPTION	BREAKER AMPS	BREAKER POLES		SERVICE LOAD VA	USAGE FACTOR	PHASE A	PHASE B VA			BREAKER STATUS	BREAKER POLES	BREAKER AMPS	LOAD DESCRIPTION	СКТ
1	RET #1	30	2	ON	7000	1.25	8750		1.00	0	ON	2	30	RET #2	2
3		30		ON	7000	1.25		8750	1.00	0	ON	-	30		4
5	RET #3	30	2	ON	0	0.00	400		1.00	400	ON	2	30	RET #4	6
7		30		ON	0	0.00		400	1.00	400	ON	-	30		8
9	RET #5	30	2	ON	960	1.00	1140		1.00	180	ON	2	30	RET #6	10
11		30		ON	200	1.00		700	1.00	500	ON	-	30		12
13	RET #7	30	2	ON	7000	1.25	8750		1.00	0	ON	2	30	RET #8	14
15		30		ON	7000	1.25		8750	1.00	0	ON	-	30		16
17	SPARE	30	2	OFF	0	0.00	0		1.00	0	OFF	2	30	SPARE	18
19		30		OFF	0	0.00		0	1.00	0	OFF		30		20
21	HVAC #1	60	2	ON	960	1.00	1140		1.00	180	ON	2	35	HVAC #2	22
23		60		ON	200	1.00		700	1.00	500	ON	-	35		24
25	HVAC #3	35	2	ON	960	1.00	1140		1.00	180	ON	2	60	SURGE ARRESTOR	26
27		35		ON	200	1.00		700	1.00	500	ON	-	60		28
29	GENERATOR	20	2	ON	0	0.00	400		1.00	400	ON	1	20	LIGHTING	30
31		20		ON	0	0.00		400	1.00	400	ON	1	20	SMOKE DETECTOR	32
33	RECEPTACLE	20	1	ON	960	1.00	7960		1.00	7000	ON	2	100	SAMSUNG MMBU CABINET	34
35	RECEPTACLE	20	1	ON	200	1.00		7200	1.00	7000	ON	-	100		36
37	RECEPTACLE	20	2	ON	960	1.00	1140		1.00	180	ON	2	15	SAMSUNG BATT FAN	38
39	RECEPTACLE	20		ON	200	1.00		700	1.00	500	ON	-	20	RECEPTACLE	40
							10290	9850	VA			TOTAL KVA	20.14		
	POST-MIGRATION PERIOD LOADING											AMPS	83.92		








# BLACK & VEATCH



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(			

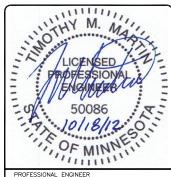

PROFESSIONAL ENGINEER
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MS72XC330-A F1/MN0330-WITHROP 19900 MANNING TRAIL N STILLWATER, MN 55082


SHEET TITLE

POST - MIGRATION PANEL SCHEDULE

SHEET NUMBER


E-4

Α

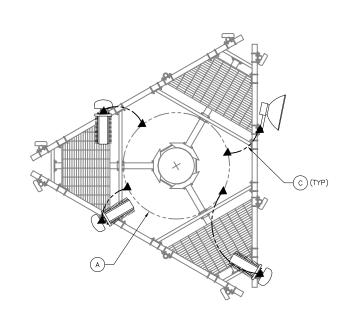

# ANTENNA GROUNDING PLAN

SCALE: 3/8"=1'-0"

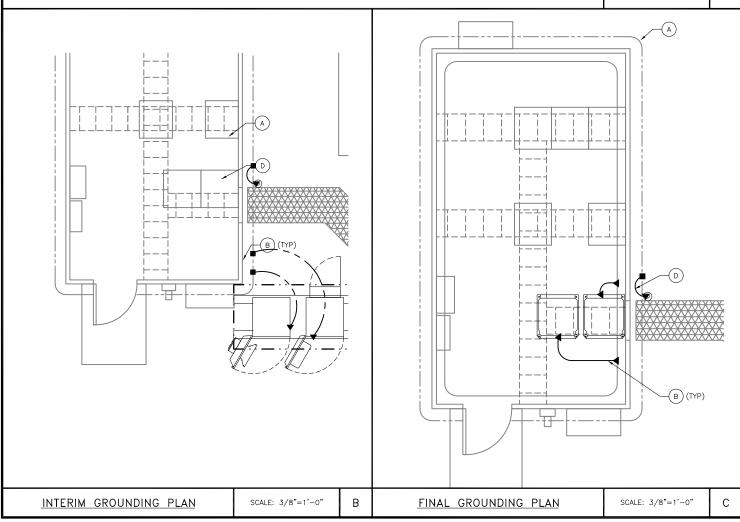

# GROUNDING NOTES

- 1. ALL ELECTRICAL AND GROUNDING AT THE CELL SITE SHALL COMPLY WITH THE NATIONAL ELECTRICAL CODE (NEC), NATIONAL FIRE PROTECTION ASSOCIATION (NFPA) 780 (LATEST EDITION), AND MANUFACTURER SPECIFICATION.
- 2. IF THE AC PANEL IN THE POWER CABINET IS WIRED AS SERVICE ENTRANCE, THE AC SERVICE GROUND CONDUCTOR SHALL BE CONNECTED TO GROUND ELECTRODE SYSTEM. WHEN THE AC PANEL IN THE POWER CABINET IS CONSIDERED A SUB-PANEL, THE GROUND WIRE SHALL BE INSTALLED IN THE AC POWER CONDUIT. THE INSTALLATION SHALL BE PER LOCAL AND NATIONAL ELECTRIC CODE (NFPA-70).
- 3. EXOTHERMIC WELDING IS RECOMMENDED FOR GROUNDING CONNECTION WHERE PRACTICAL. OTHERWISE, THE CONNECTION SHALL BE MADE USING COMPRESSION TYPE-2 HOLES. LONG BARREL LUGS OR DOUBLE CRIMP CLAMP "C" CLAMP. THE COPPER CABLES SHALL BE COATED WITH ANTIOXIDANT (COPPER SHIELD) BEFORE MAKING THE CONNECTIONS. THE MANUFACTURER'S TORQUING RECOMMENDATIONS ON THE BOLT ASSEMBLY TO SECURE CONNECTIONS SHALL BE FOLLOWED.
- 4. THE ANTENNA CABLES SHALL BE GROUNDED AT THE TOP AND BOTTOM OF THE VERTICAL RUN FOR LIGHTING PROTECTION. THE ANTENNA CABLE SHIELD SHALL BE BONDED TO A COPPER GROUND BUSS AT THE LOWER MOST POINT OF A VERTICAL RUN JUST BEFORE IT BEGINS TO BEND TOWARD THE HORIZONTAL PLANE. WIRE RUNS TO GROUND SHALL BE KEPT AS STRAIGHT AND SHORT AS POSSIBLE. ANTENNA CABLE SHIELD SHALL BE GROUNDED JUST BEFORE ENTERING THE CELL CABINET. ANY ANTENNA CABLES OVER 200 FEET IN LENGTH SHALL ALSO BE EQUIPPED WITH ADDITIONAL GROUNDING AT MID—POINT.
- 5. ALL GROUNDING CONDUCTORS INSIDE THE BUILDING SHALL BE RUN IN CONDUIT RACEWAY SYSTEM, AND SHALL BE INSTALLED AS STRAIGHT AS PRACTICAL WITH MINOR BENDS TO AVOID OBSTRUCTIONS. THE BENDING RADIUS OF ANY #2 GROUNDING CONDUCTOR IS 8". PVC RACEWAY MAY BE FLEXIBLE OR RIGID PER THE FIELD CONDUITONS. GROUNDING CONDUCTORS SHALL NOT MAKE CONTACT WITH ANY METALLIC CONDUITS, SURFACES OR EQUIPMENT.
- 6. PROVIDE PVC SLEEVES WHERE GROUNDING CONDUCTORS PASS THROUGH THE BUILDING WALLS AND /OR CEILINGS.
- 7. INSTALL GROUND BUSHINGS ON ALL METALLIC CONDUITS AND BOND TO THE EQUIPMENT GROUND BUSS IN THE PANEL BOARD.
- 8. GROUND ANTENNA BASES, FRAMES, CABLE CABINETS AND OTHER METALLIC COMPONENTS WITH #2 GROUNDING CONDUCTORS AND CONNECT TO INSULATED SURFACE MOUNTED GROUND BARS. CONNECTION DETAILS SHALL FOLLOW MANUFACTURER'S SPECIFICATIONS FOR GROUNDING.
- 9. ALL PROPOSED GROUNDING CONDUCTORS SHALL BE ROUTED AND CONNECTED TO THE MAIN GROUND BAR OR EXISTING GROUND HALO THROUGH EXISTING OR PROPOSED CABLE LADDER SUPPORT.

# GROUNDING LEGEND

- A EXISTING GROUND RING OR EXISTING HALO GROUNDING. FIELD DETERMINE EXACT LOCATION.
- $\begin{picture}(60,0) \put(0,0){\line(0,0){10}} \put(0,0$
- C ANTENNA GROUNDING, SEE DETAIL E / SHEET G-3
- D GPS GROUNDING, SEE DETAIL D / SHEET G-3
- (E) CABLE LADDER SUPPORT GROUNDING
- F PROPOSED GROUND RING, FIELD DETERMINE EXACT LOCATION
- ---- EXISTING GROUND RING
- --- PROPOSED GROUND RING
  - CADWELD CONNECTION (EXOTHERMIC WELD)
  - ▲ MECHANICAL CONNECTION

	CADWELD CONNECTIONS  OR APPROVED EQUAL	
PARALLEL HORIZONTAL CONDUCTORS PARALLEL THROUGH CONNECTION OF HORIZONTAL CABLES TYPE PT	HORIZONTAL STEEL SURFACE TO FLAT STEEL SURFACE OR HORIZONTAL PIPE TYPE HS	BOND JUMPER FIELD FABRICATED GREEN STRANDED INSULATED TYPE 2-YA-2
THROUGH CABLE TO GROUND ROD THROUGH CABLE TO TOP OF GROUND ROD TYPE GT	VERTICAL STEEL SURFACE CABLE DOWN AT 45' TO VERTICAL STEEL SURFACE INCLUDING PIPE TYPE VS	COPPER LUGS TWO HOLE - LONG BARREL LENGTH TYPE YA-2
VERTICAL PIPE CABLE DOWN AT 45' TO RANGE OF VERTICAL PIPES TYPE VS		

TYPICAL CADWELD TYPE CONNECTIONS










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-	DRA	WN BY:	SAF
-	CHE	CKED BY:	SEW
-	$\equiv$		
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.,.,.,.	REV	DATE	DESCRIPTION
0 10/03/12 100% ISSUED FOR CONSTRUCTION	Α	07/23/12	90% ISSUED FOR REVIEW
	В	10/01/12	90% ISSUED FOR PERMITTING
1 10/17/12 100% ISSUED FOR CONSTRUCTION	0	10/03/12	100% ISSUED FOR CONSTRUCTION
	1	10/17/12	100% ISSUED FOR CONSTRUCTION

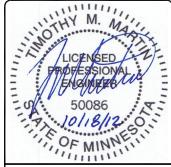

PROFESSIONAL ENGINEER
I hereby certify that this plan, specification, or report was prepored by me or under my direct supervision and that I am a duly Licensed Professional Engineer under the laws of the State of Minnesota.


MS72XC330-A F1/MN0330-WITHROP 19900 MANNING TRAIL N STILLWATER, MN 55082

SHEET TITLE

**GROUNDING PLAN & NOTES** 

SHEET NUMBER

G-1

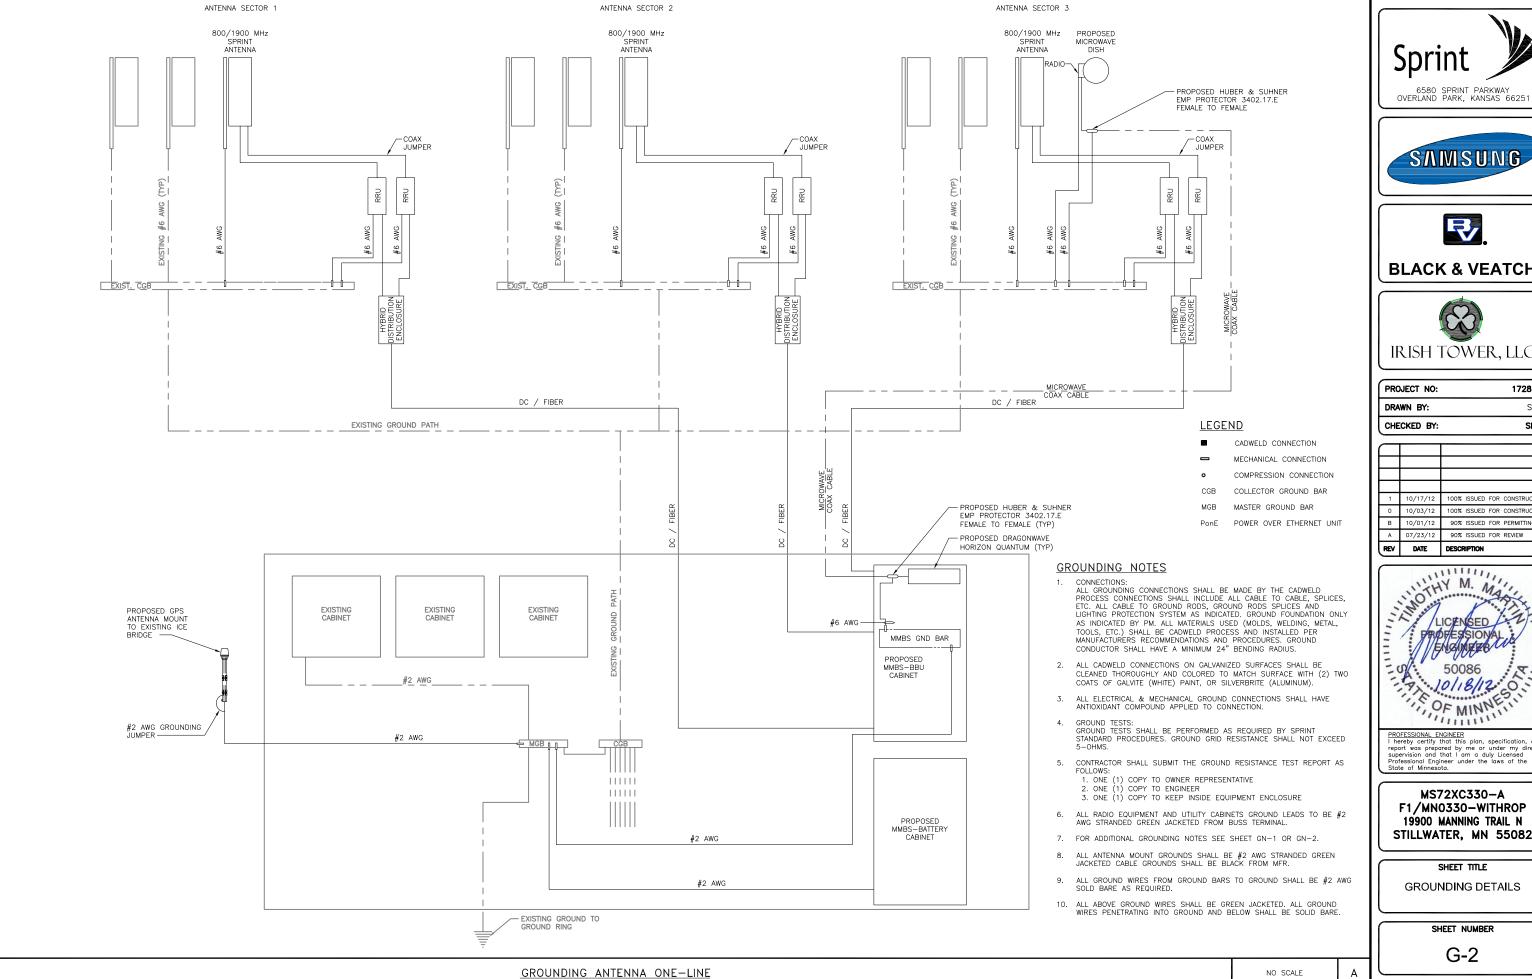



# **BLACK & VEATCH**



PROJECT NO:	172862
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CHECKED BY:	SEW


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PROFESSIONAL ENGINEER
I hereby certify that this plan, specification, or report was prepored by me or under my direct supervision and that I am a duly Licensed Professional Engineer under the laws of the State of Minnesota.

MS72XC330-A F1/MN0330-WITHROP 19900 MANNING TRAIL N STILLWATER, MN 55082

**GROUNDING DETAILS** 





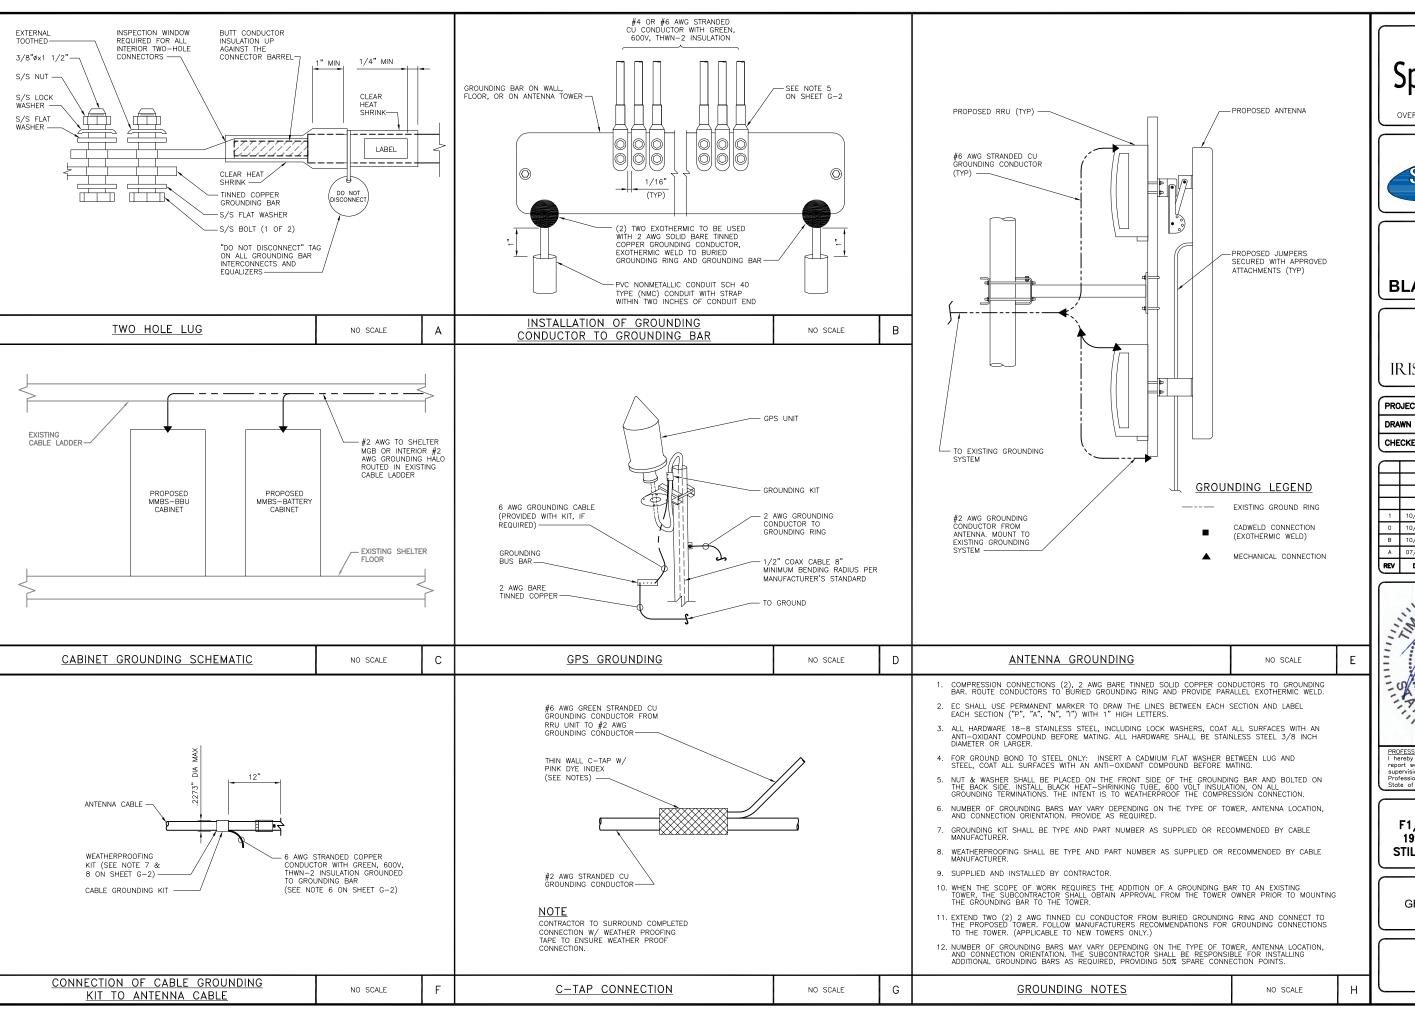




**BLACK & VEATCH** 



PROJECT NO:	172862
DRAWN BY:	SAF
CHECKED BY:	SEW

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PROFESSIONAL ENGINEER
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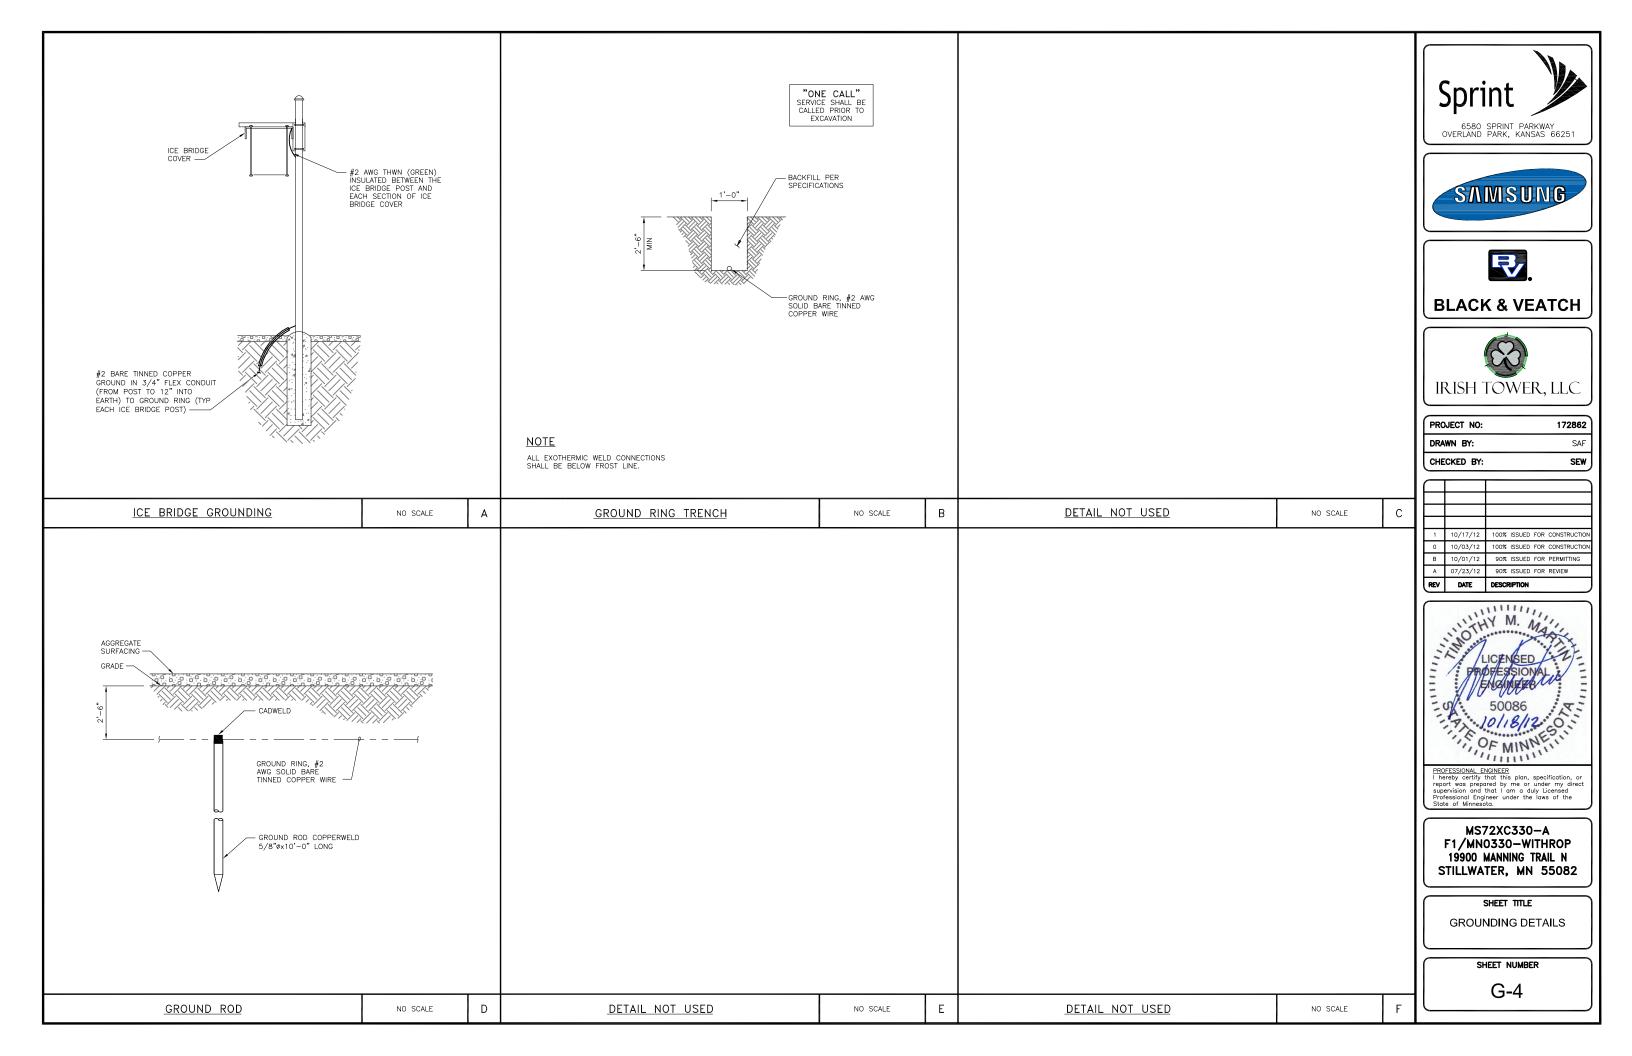
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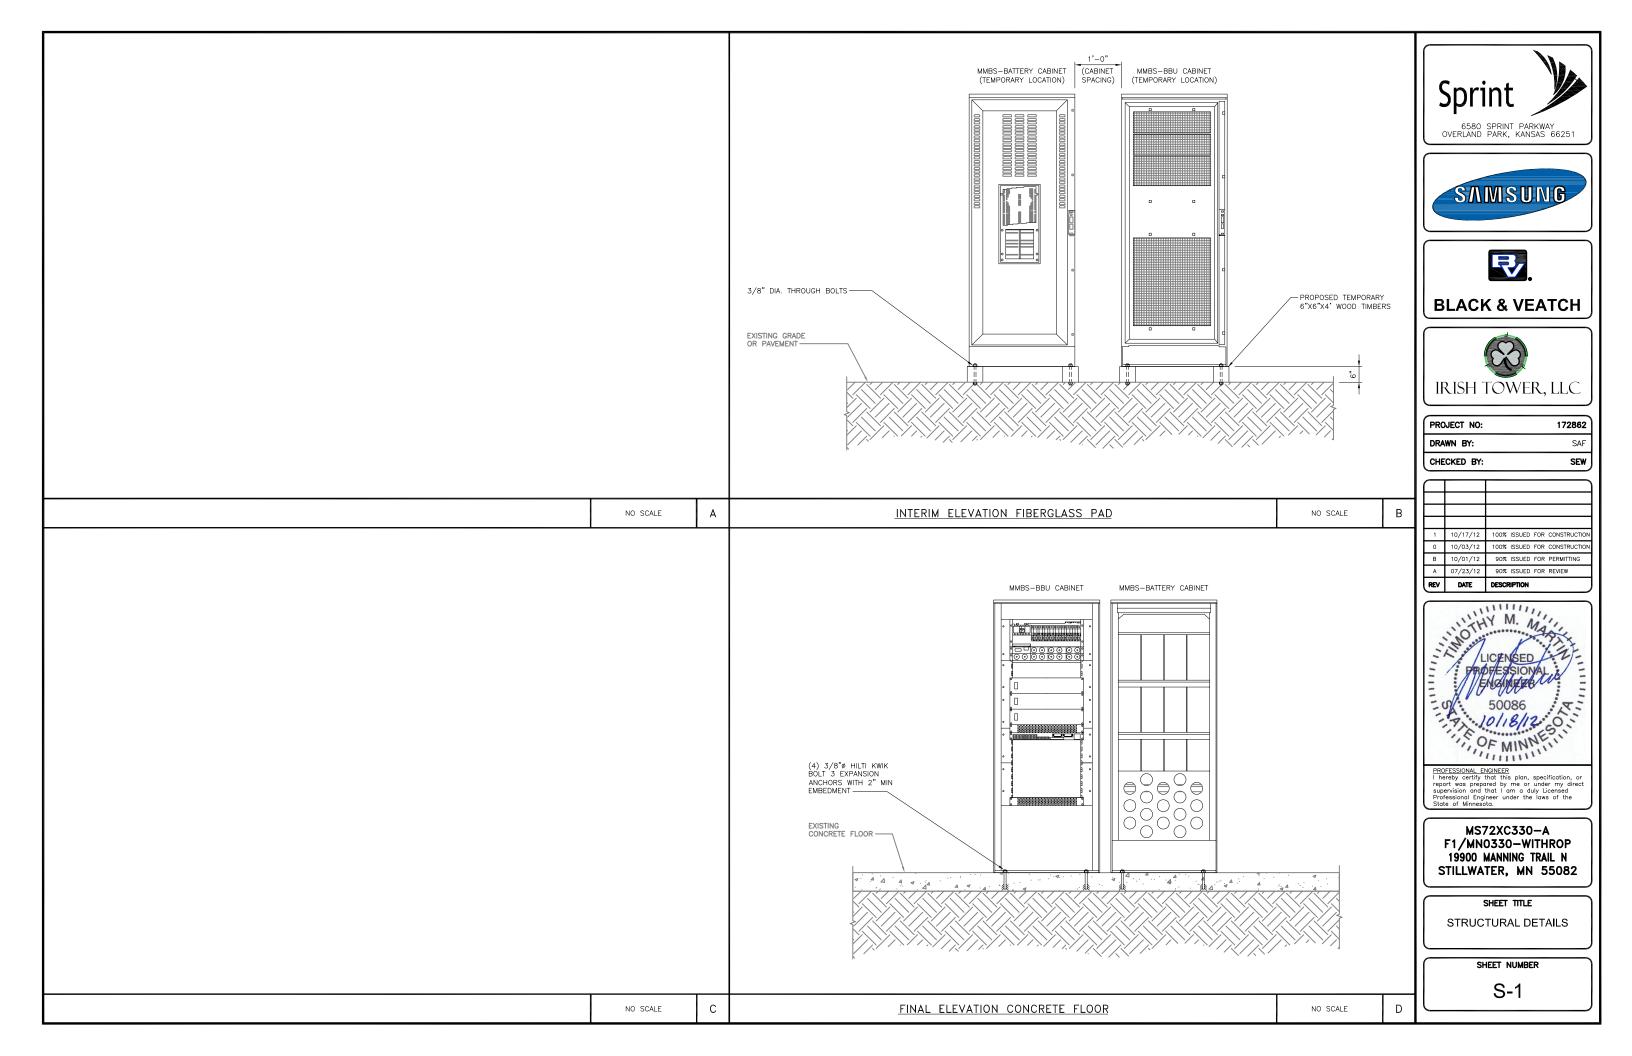
SHEET TITLE

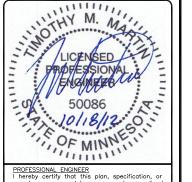
GROUNDING DETAILS

SHEET NUMBER

G-3





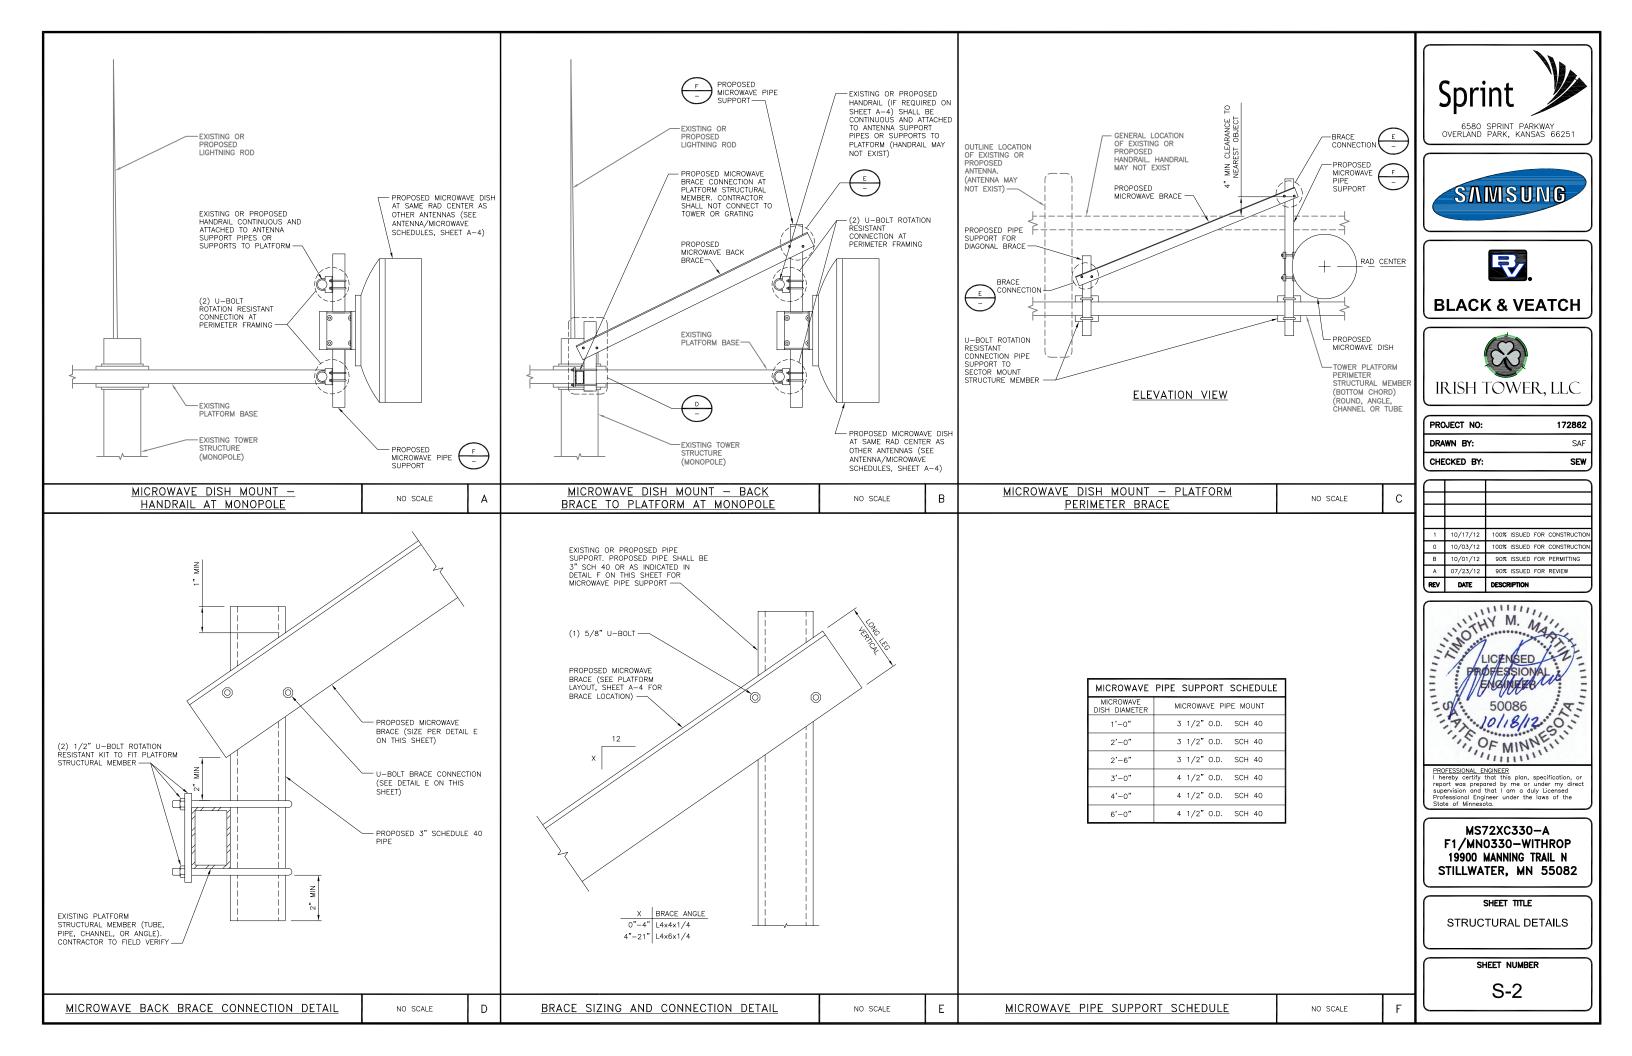

701 Xenia Avenue South Suite 300 Minneapolis, MN 55416 Tel: 763-541-4800 Fax: 763-541-1700

# Memorandum

To: Grant Planning Commission Meeting November 19, 2012

Grant City Council Meeting December 4, 2012

From: Breanne Rothstein, City Planner

WSB & Associates

Date: November 8, 2012

Re: Application from Jessica and Christine Flug (8255 75th St. N) for a Conditional

Use Permit to allow for a horseboarding facility at more than one horse per every

two grazable acres- WSB Project # 1936-25

# **Request:**

On October 15, 2012, the City received an application from Jessica and Christine Flug for a conditional use permit to allow for a horse boarding business of more than ten horses at a density greater than one horse per every two grazable acres. In total, they are seeking a permit to allow for the boarding/pasturing of 95 animal units as a business, of which 20 horses would be housed in a paddock in a future building on site. Horse boarding has been conducted on this property for many years and was approved for up to 50 horses in 1982 according to meeting minutes.

# **Site Characteristics:**

The subject property is located at 8255 75st St N (westernmost edge of Grant) and is a total of 164 acres, of which approximately 105 acres would be fenced in for a pasture area. The site is characterized by agricultural use (row crops), wetlands, and some forested areas. Approximately ½ of the total pasture area is wetland. It is surrounded by agricultural/wetland and an existing horse boarding facility owned by the applicant to the south and east, a residential subdivision to the west (Mahtomedi), and the school property to the north. The Gateway trail runs along the south side of the property, and offers a gravel horse trail for riders.

There are several buildings on the site, including a homestead, one large barn, a large garage, several smaller sheds, and a chicken coop. One barn is proposed to be removed and replaced in the future as part of the effort to make it useable for storage related to the proposed operation.

# **Grant City Code Requirements:**

Horse boarding is a permitted use in the agricultural zoning district at a density of one animal unit per two grazable acres, up to ten horses. Section 32-328 and Section 32-337 allows for property owners to exceed these limitations through the application of a conditional use permit, and subject to the following requirements:

- Must demonstrate that facilities are present and appropriate practices are being employed to preclude surface water or groundwater contamination, excessive manure accumulation, odor, noise or other nuisances
- The applicant must have a state pollution control agency feedlot permit for the proposed use
- Submission of a plan for the storage and removal of manure and control of odors from the operation
- Traffic and parking plan for the operation of the boarding and training facility
- Lighting Plan
- Schedule of plan for equestrian events (sorting, rodeo, shows) to be held on site, hours of operation
- Plan to dissipate noise and compliance with noise regulations
- Fencing and building plans with setbacks

Additionally, city code specifies standards for approving all conditional use permits, which are listed below:

- The use conforms with the City's Comprehensive Plan
- The use will not be detrimental to or endanger the public health, safety or general welfare of the city, its residents, or the existing neighborhood
- The use is compatible with the existing neighborhood
- The use meets conditions or standards adopted by the city through other ordinances
- The use will not create additional requirements for facilities and services at public cost beyond normal uses
- The use will not involve use or activities that will be detrimental to people, property, or the general welfare because of production of traffic, noise, smoke, fumes, glare, odors or any other nuisances
- The use will not result in the destruction, loss or damage of natural, scenic, or historic features of importance
- The use will not increase flood potential or create additional water runoff onto surrounding properties

# **Analysis:**

The application has been deemed complete for review by the city planner, therefore the city has 60 days to take action from the date of application, unless an additional 60 days is requested. The initial 60 day deadline for action is December 14, 2012.

A site visit of the property was conducted with the applicant, MPCA staff for feedlot permitting, and the city planner on November 7, 2012. At that meeting, a description of the land use, fencing projects, and permitting requirements was outlined.

A site plan and fencing plan were included in the application, and attached herein.

# Manure Management

The applicant proposes to keep any manure at least 100 feet from a wetland edge. Furthermore, the applicant proposes to scrap and remove all manure in the paddock area once per year, and

CUP Application: Flug November 10, 2012 Page 3

dispose of the material off-site. The pasture area is not planned to be cleaned-passive manure management is proposed. The applicant will be required to follow the rules associated with feedlot operations through the Minnesota Pollution Control Agency. Minnesota Rules Chapter 7020.0350 subpart 2, requires registration for "an animal feedlot capable of holding 50 or more animal units..." A copy of such registration will be a condition listed in the conditional use permit. Also according to these rules, records of manure management are required to be kept by the applicant for over 100 animal units.

The Valley Branch Watershed District does not require a permit for this application. The applicant is working with the Washington Conservation District regarding suggestions for best management practices.

# Events

The horse boarding operation is proposed to be open 7:00 a.m. to 11:00 p.m.

In discussions with the applicant, they are requesting to be able to conduct up to five events per year that would be open to the public (horse shows, boarder meetings, etc). The site's location off of County Road 19 is suitable for vehicular access, and there are large areas on the site that can accommodate adequate short-term parking on a limited basis.

# Compliance with other terms of Conditional Use Permit

This application is consistent with the Comprehensive Plan's vision of remaining a rural community with an emphasis on preserving the agricultural uses. The existing neighboring land uses are predominantly agricultural; however, there is an existing, single-family neighborhood nearby, although not immediately adjacent to, the property.

The proposed use does require MPCA registration, which is in process. The MPCA institutes these regulations in order to protect the health, safety, and welfare of the general public and surrounding neighbors and minimize any impacts. The proposal is under the threshold for requiring any stormwater management practices or plan (minimum of 300 animal units).

No additional parking or lighting facilities are proposed as part of this application.

# **Staff Recommendation:**

Should the Planning Commission recommend approval of the application, staff recommends the following conditions be placed on the conditional use permit;

- 1) A maximum of 95 animal units be permitted to occupy the property at any one time, with a maximum of 20 horses to be housed in a paddock area;
- 2) Manure is kept a minimum of 100 feet from any wetland edge;
- 3) MPCA registration is completed, and a copy is sent to WSB and the City:
- 4) All manure stockpiling be located a minimum of 100 feet from any wetland;
- 5) Records of manure management are kept, and available to city staff upon request;
- 6) Lighting and noise must meet the requirements of the City's ordinances;
- 7) Hours of operation should be consistent with other CUPs for this use, and follow 7 a.m. to 9 p.m.;

CUP Application: Flug November 10, 2012 Page 4


- 8) Public events are limited to no more than five per year, and must follow limited hours of 9 a.m. to 7 p.m.;
- 9) All fencing shall be installed according to the submitted site plan and be properly maintained;
- 10) The applicant shall implement the recommendations of the watershed district and/or the Washington Conservation District;
- 11) All fees and escrows in conjunction with this application are paid in full;
- 12) City shall be allowed to inspect the property with 24 hours' notice to the applicant (up to five times per year). Periodic review of the CUP on a complaint and annual basis is permitted by the City to allow for annual review of compliance with the terms of the CUP. The Applicants shall comply with City Ordinances that require Applicant to pay a CUP review fee;
- 13) Applicants shall be fined \$300 per animal unit if the total number of animal units is exceeded, upon inspection from the city. Such fines shall be due and payable within 10 days of the date of notification from the City, and failure to make payment shall constitute a violation of the Conditional Use Permit and shall subject the permit to suspension or revocation.

# **Recommended Motion:**

Motion to recommend that the City Council approve the request for a conditional use permit, subject to the conditions listed in the staff report, and direct staff to prepare a resolution declaring terms of the same.

# **Attachments:**

- 1) Application submittal
- 2) Exhibit of site location
- 3) Information from MPCA regarding feedlots

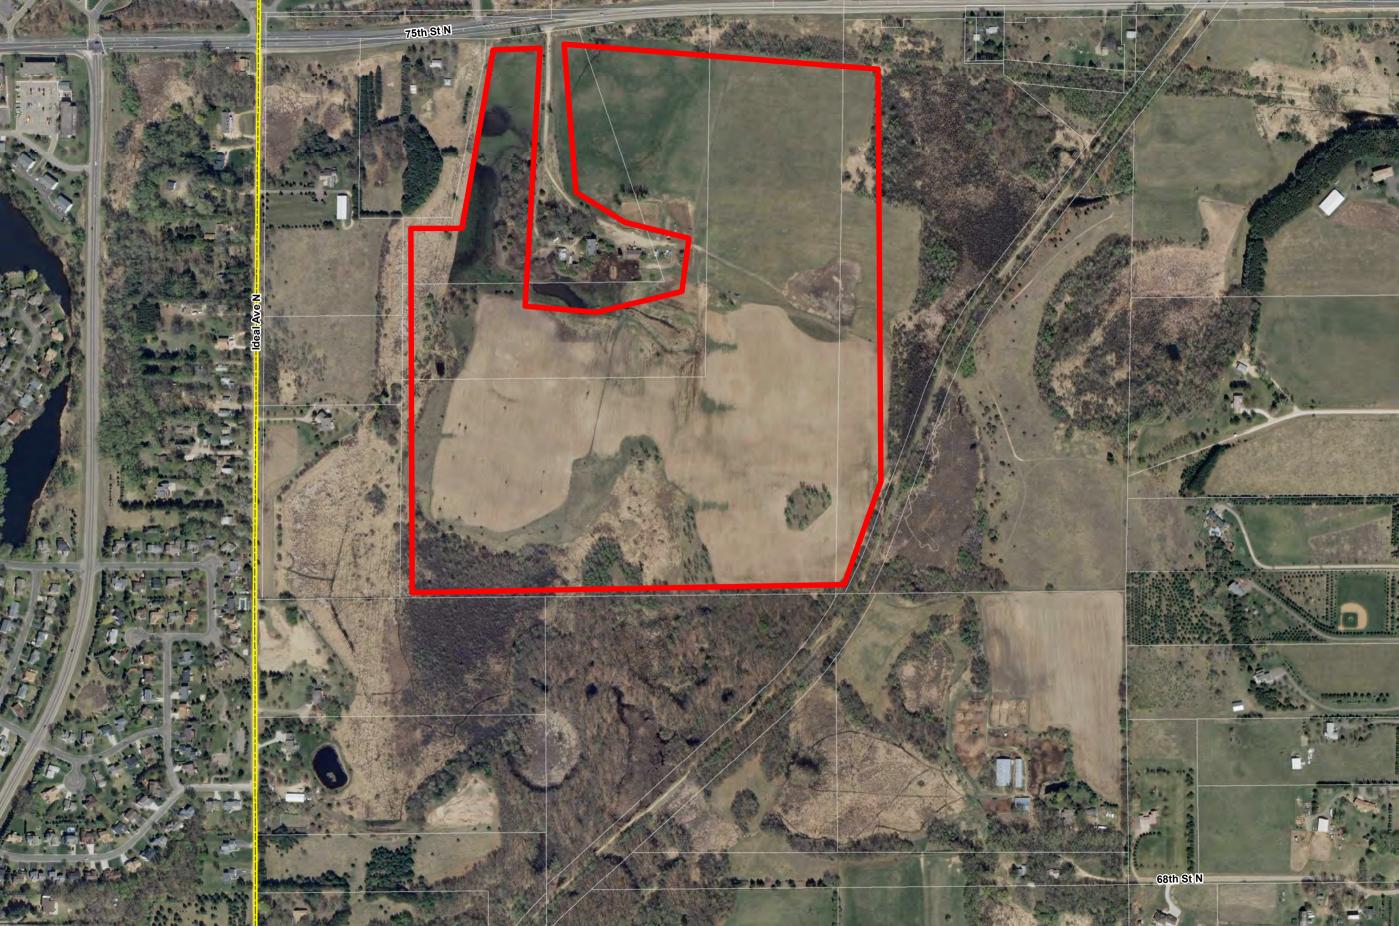



## LAND USE REQUEST APPLICATION FORM

#### **CITY OF GRANT**

Mailing Address: P.O. Box 577
Willernie, Minnesota 55090
Town Hall: 111 Wildwood Road
Phone: (651) 426-3383 Fax: (651) 429-1998
E-mail: cityclrk@visi.com

Receipt No.	

FEE: 4000 H

Makes checks payable to City of Grant.

Street Location of Property: 8255 75th Street North  Legal Description of Property: Attached	
Parcel Identification Number (PIN): <u>38.030.21.43.0003, 28.630.21.34.0001, 28.630.21.31.0003, 28.030.21.31.0005</u> Fee Owner: Name: <u>Christine Flug</u> Phone: <u>612-3860872</u> 33.030.21.21.	,J
Fee Owner: Name: Christine Flug Phone: 612-3860872 33,030-21,21.	,0002
Address: 8324 60th Freet North	
City: Still maker State: MW Zip: 55087	
Applicant (if other than owner):	
Name: anotine & Jessyca Flug Phone: 6/2-600-1044	
Address: \$2.55 75th Street North	
City: Stilluate State: MN Zip: 55082	
Type of Request: Conditional Use Permit (CUP)	
Description of Request (be as specific as possible, attach additional sheet if necessary):	
Present Zoning Classification: A-2 Total Acres: 164.97	
Is there contiguous property under the same ownership?	
Proof of Ownership: Deed Title Opinion Attorney Letter Abstract	
Existing Use of the Property: hoze boarding	
Proposed Use of the Property: No se boarding.	
Has a request for Rezoning, Variance or Special Use Permit on the subject site or any part thereof been previously sought?	
All requests for planning action must be accompanied by a completed Checklist Form and appropriate notations of compliance. Applicant understands that all fees incurred resulting from the review of this request will be the responsibility of the undersigned. This application will not be considered until all fees and escrow amounts are paid in full.	
Signature of Applicant: Usayan Glug Date: 9/17/12	
For City Use Only: Date Filed:	
Fee and Escrow Amounts Paid in Full:   Yes OR  No Total Amount (See Above):	
Accepted as Complete on: Received By:	
60 Day Deadline: Last City Council meeting date before the 60 day deadline:	
Approved □ Denied □ by the Planning Commission on	
Approved □ Denied □ by the City Council on	

Extension of Time Deadlines: You are hereby notified that this application is not complete until reviewed by the City Planner, City Engineer and City Attorney. The City Planner, City Engineer or City Attorney will notify you within 10 days if your application is complete. The City of Grant may extend the time deadlines pursuant to M.S. Section 15.99 with respect to the written request you have made to the City. The extension may be made for an additional sixty (60) days. In the event the City deems an extension is necessary it will advise you in writing as to why it extended the deadline, as well as, provide you with a date when the City will complete its deliberation on your application.

References: In signing this application, I hereby acknowledge that it is the applicant's responsibility to know the requirements of the City code. References for sale from the City Clerk include Grant's Comprehensive Plan, Zoning Ordinance, Subdivision Ordinance, and other ordinances. The Shoreland Management, Mining, and Floodplain ordinances, Individual Sewage Treatment System Regulations manual and aerial photos may be obtained from Washington County offices in Stillwater. Most ordinances are posted on the City website, although only copies from the City/County offices should be considered official.

Acceptance: I understand that this application shall not be accepted by the City until all information and copies as required by Ordinance or Resolution of the City Council have been provided to the City Clerk and fees are paid. The fact that the City Clerk accepts an application does not imply that it is accurate or complete. That determination is only made after a thorough review by the City Planner, City Engineer and others as defined by Ordinance.

**Financial:** Fees include an application fee and administration fee as adopted by Resolution of the City Council, and a deposit to be specified by the City Clerk for the purpose of paying all processing expenses incurred by the City in this matter. If expenses are greater than the initial deposit, further funds must be deposited by the applicant or the process stops and a delay may result.

I understand that I am responsible for, and hereby agree to pay all expenses, incurred by the City, with regard to this Application. This will include administrative costs, planning, engineering and legal fees, and other professional consultant fees that the City may incur. These expenses shall be paid by me, the Applicant, before any City approval is given. I agree that the City may withhold the issuance of any permits or licenses which I seek (including Building Permits) if I am delinquent in the payment of any City costs or fees.

I further understand that the deposit or escrow amount collected for the payment of expenses may be held for a period of up to one year from the date of application, or in the case of a minor or major subdivision, until the project has been completed and all necessary disbursements are made to the satisfaction of the City.

Site Visits: The undersigned hereby consents that the City of Grant officials, employees, appointed commissioners and consultants hired by the City may enter the property to inspect the layout of structures, proposed placement of planned structures and additions, and the property's site features and dimensions.

Property Owner Applicant (if not property Owner)	
The following documents were supplied to the applicant:	
Timelines Resolution	Calendar of Meetings
Fee Schedule	Major Subdivision Guideline
Minor Subdivision Guideline	Variance Application Guideline
Conditional Use Permit Guideline	Other:

This is an application for horse boarding on the property consisting of 164 acres on

**PIDs** 

28.030.21.42.0003 28.030.21.34.0001 28.030.21.31.0003 28.030.21.31.0002 33.030.21.21.0002

The property has been previously approved and used for horse boarding by John and Jean Kokhler and then Paul Bruggamen. As the current owner of the property, I would like to board up to 75 horses on pasture and 20 horses in paddock/box stalls. All feed and manure for paddock horses will be provided from offsite and removed off site. Based on the requirements of ordinance 32 section 32-328, the property will comply by the following:

- 1) All paddock areas will be scrapped and the manure removed from the property on a minimum of an annual basis to a location that has the ability to properly utilize it as compost. No manure will be piled within 100 feet of a wetland. There are no streams or other moving water in the property
- 2) No drainage from a paddock area will be allowed to go into a wetland or to create ground water contamination.
- 3) No lighting currently violates section 32-321 or will be installed that would violate section 32-432
- 4) The property shall have operating hours of 7:00 am to 11:00 pm and shall comply with section 32-332 regarding noise. There will be no on-street parking. The property entrance is on a county road that is a main thoroughfare so there is no discernible impact to neighbors
- 5) Horse shows and training exhibitions would be allowed that do not violate the noise, lighting, parking, or hours of operation conditions.
- 6) Fencing will be complient with normal fencing for horse containment and all setbacks requirements for buildings shall be maintained.

#### **Stewart Title Guaranty Company**

Issued by its Agent, Land Title, Inc. 2200 West County Road C, Suite 2205 Roseville, MN 55113

#### COMMITMENT

#### SCHEDULE A

Commitment No. 339145

6th Supplemental Case No. 339145

#### EXHIBIT A

#### Parcel A:

That part of the West half of the Southeast Quarter of Section 28, Township 30, Range 21, Washington County, Minnesota, according to the government survey thereof; described as follows: Beginning at the intersection of the West line of said West half of the Southeast Quarter and the South line of Washington County Right of Way Plat No. 19; thence North 88 degrees 31 minutes 17 seconds East, on a bearing based on the Washington County coordinate system, South zone, along said South plat line a distance of 169.11 feet, thence South 1 degree 28 minutes 43 seconds East along said plat line a distance of 35.00 feet; thence North 88 degrees 31 minutes 17 seconds East along said plat line a distance of 100.00 feet; thence North 1 degree 28 minutes 43 seconds West along said plat line a distance of 35.00 feet; thence North 88 degrees 31 minutes 17 seconds East along said plat line a distance of 276.71 feet to a point on a line parallel with and 545.80 feet West of the West line of said West half of the Southeast Quarter, as measured along the North line of said West half of the Southeast Quarter, thence South 0 degrees 00 minutes 37 seconds West along said parallel line a distance of 188.32 feet; thence North 88 degrees 36 minutes 30 seconds East and parallel with the North line of said West half of the Southeast Quarter a distance of 175,00 feet; thence South 00 degrees 00 minutes 37 seconds West a distance of 60.00 feet; thence South 51 degrees 41 minutes 18 seconds East a distance of 489.02 feet to the Westerly right-of-way line of the Soo Line Railroad, as the same is now located, thence Southwesterly along said Westerly right-ofway line to the South line of said West half of the Southeast Quarter; thence South 88 degrees 36 minutes 02 seconds West along said South line a distance of 39.53 feet to the Southwest corner of said West half of the Southeast Quarter; thence North 0 degrees 90 minutes 37 seconds East along the West line of said West half of the Southeast Quarter a distance of 2573.45 feet to the point of beginning.

AND

#### Parcel B:

All that part of the Northeast Quarter of the Northwest Quarter (NE 1/4 of NW 1/4) and all that part of the Northwest Quarter of the Northwest Quarter (NW 1/4 of NE 1/4) of Section Thirty-three (33), in Township Thirty (30) North, of Range Twenty-one (21) West, Grant Township, Washington County, Minnesota, lying Westerly of the Northwesterly R/W of the Minneapolis, St. Paul and Sault St. Marie Railroad.

AND

This commitment is invalid unless the Insuring Provisions and Schedules A and B are attached.

Schedule A consists of 4 page(s)

#### Stewart Title Guaranty Company

Issued by its Agent, Land Title, Inc. 2200 West County Road C, Suite 2205 Roseville, MN 55113

#### COMMITMENT

#### SCHEDULE A

Commitment No. 339145

6th Supplemental Case No. 339145

#### Parcel C:

That part of the Southwest Quarter of Section 28, Township 30, Range 21, Washington County, Minnesota described as follows: Beginning at the intersection of the West line of the East 1/2 of the West 1/2 of said Southwest 1/4 and the North line of the South 1705.07 feet of said Southwest 1/4; thence South 0° 18° 28" East along said West line a distance of 296.30 feet; thence North 88° 38° 54" East a distance of 1175.23 feet; thence North 19° 35° 52" West to the center line of County State Aid Highway No. 12; thence Westerly along said center line to the center line of a Minnesota Pipe Line Company easement as now laid out across said Southwest 1/4; thence Southerly along the center line of said easement to the North line of the South 1705.07 feet of said Southwest 1/4; thence West to the point of beginning.

AND

#### Parcel D:

East 1/2 of the Southwest 1/4 of Section 28, Township 30 Range 21 in Washington County, Minnesota.

Also that part of the East 1/2 of the West 1/2 of the Southwest 1/4 of Section 28 lying South of the center line of County State Aid Highway No. 12 as now laid out and traveled except the South 980.38 feet of said East 1/2 of the West 1/2 of the Southwest 1/4 and except that part lying Westerly of the center line of a Minnesota Pipe Line Company Easement as now laid out across the Southwest 1/4 of said Section 28 and lying Northerly of the South 1705.07 feet of said East 1/2 of the West 1/2 of the Southwest 1/4 as measured along the West line thereof. Subject to the right of way of County State Aid Highway No. 12 as now laid out and traveled along the North line of said Southwest 1/4 and subject to a 66 foot wide easement to Minnesota Pipe Line Company as now laid out across said Southwest 1/4.

#### **EXCEPT**

That part of the Southwest Quarter of Section 28, Township 30, Range 21, Washington County, Minnesota described as follows: Beginning at the intersection of the West line of the East 1/2 of the West 1/2 of said Southwest 1/4 and the North line of the South 1705.07 feet of said Southwest 1/4; thence South 0° 18° 28" East along said West line a distance of 296.30 feet; thence North 88° 38' 54" East a distance of 1175.23 feet; thence North 19° 35° 52" West to the center line of County State Aid Highway No. 12; thence Westerly along said center line to the center line of a Minnesota Pipe Line Company easement as now laid out across said Southwest 1/4; thence Southerly along the center line of said easement to the North line of the South 1705.07 feet of said Southwest 1/4; thence West to the point of beginning.

AND EXCEPT

This commitment is invalid unless the Insuring Provisions and Schedules A and B are attached.

Schedule A consists of 4 page(s)

### Stewart Title Guaranty Company

#### Issued by its Agent, Land Title, Inc. 2200 West County Road C, Suite 2205 Roseville, MN 55113

#### COMMITMENT

#### SCHEDULE A

Commitment No. 339145

6th Supplemental Case No. 339145

The East 600 feet and the South 980.38 feet of said East 1/2 of the Southwest 1/4.

AND

#### Parcel E:

The East 600.00 feet of the Southwest 1/4; thence South 980.38 feet of the East 1/2 of the Southwest 1/4 lying West of the East 600.00 feet thereof and the South 980.38 feet of the East 1/2 of the West 1/2 of the Southwest 1/4 all in Section 28, Township 30, Range 21, Washington County, Minnesota.

This commitment is invalid unless the Insuring Provisions and Schedules A and B are attached.

Schedule A consists of 4 page(s)



### CONDITIONAL USE PERMIT (CUP) APPLICATION CHECKLIST

#### **CITY OF GRANT**

Mailing Address: P.O. Box 577
Willernie, Minnesota 55090
Town Hall: 111 Wildwood Road
Phone: (651) 426-3383 Fax: (651) 429-1998
E-mail: cityclrk@visi.com

Receipt No.			
ESCROW:			
FEE:			

Makes checks payable to City of Grant.

GENERAL REQUIREMENTS:			INCLUDED IN SUBMITTAL		
1.	Application Form	Έβ√YES	□ NO .		
2.	Fees	Ø YES	□ NO		
3.	Escrow	ˈβ⁄⁄/ YES	□ NO		
4.	Complete legal description	Ø YES	□ NO		
5.	A description of the request (either on the application form or in a letter)	Ø YES	□ NO		
6.	Public Hearing mailing list of property owners within 1,250 feet of the property boundaries. Contact Washington County Surveyor's Office: (651) 430-6875.	ŞØYES	□ NO		
7.	Site Plan	∕ ØPYES	□ NO		
	<ul> <li>4 plan sets, 22" x 34"</li> <li>15 plan sets, 11" x 17"</li> </ul>				

#### Plan Sheet Requirements:

- Title block
- Name, address, phone number for owner, developer, surveyor, engineer
- Date of preparation and revision dates
- North Arrow
- Graphic scale not less than 1:100


#### SITE PLAN REQUIREMENTS

Existing and Proposed:		INCLUDE	INCLUDED IN SUBMITTAL		
1.	Site plans drawn to scale showing property lines and dimensions	Ø YES	□ NO	□ N/A	
2.	Area in acres and square feet	Ø YES	□ NO	^□ N/A	
3.	Setbacks	Ø YES	□ NO	□ N/A	
4.	Buildable area	☐ YES	□ NO	;⊠ N/A	
5.	Location of all buildings and their size and dimensions, including square footage.	X YES	□ NO	□ N/A	
6.	Vegetation, landscaping, and screening plans including species and size of trees and shrubs proposed.	YES	□ NO	□ N/A	
7.	Wetland delineation	☐ YES	□ NO	A/N Z	
8.	Topographic contours at 2-foot intervals, bluff line (if applicable)	☐ YES	□ NO	⊠ N/A	
9.	Waterbodies, Ordinary High Water Level and 100 year flood elevation	☐ YES	□ NO	∀Q N/A	
10.	Curb cuts, driveways, access roads, parking spaces, off-street loading areas, and sidewalks	□ YES	□ NO	A'N Æ	
11.	Finished grading and drainage plan sufficient to drain and dispose of all surface water accumulated.	☐ YES	□ NO	Ų N∕A	
12.	Type of business or activity and proposed number of employees. — $U ho$ $to$ $5$	YZ YES	□ NO	□ N/A	

Date Received:	
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# CONDITIONAL USE PERMIT (CUP) APPLICATION CHECKLIST City of Grant, Minnesota

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13.	Proposed floor plan and elevations of any building with use indicated.	☐ YES	□ NO	D\N/A
14.	Sanitary sewer and water plan with estimated flow rates.	☐ YES	□ NO	A/N/A
15.	Soil type and soil limitations for the intended use. If severe soil limitations for the intended use are notes, a plan or statement indicating the soil conservation practice or practices to be used to overcome said limitation shall be made part of the application.	☐ YES	□ NO	□ N/A
16.	A location map showing the general location of the proposed use within the community.	YES YES	□ NO	□ N/A
17.	A map showing all principal land use within twelve hundred fifty (1,250) feet of the parcel for which the application is being made.	NOT PES	□ №	□ N/A
18.	Location of wells and septic systems on adjacent properties.	YES	□ NO ;	N/A D
19.	Additional information relevant to the request	TE YES	□ NO	□ N/A



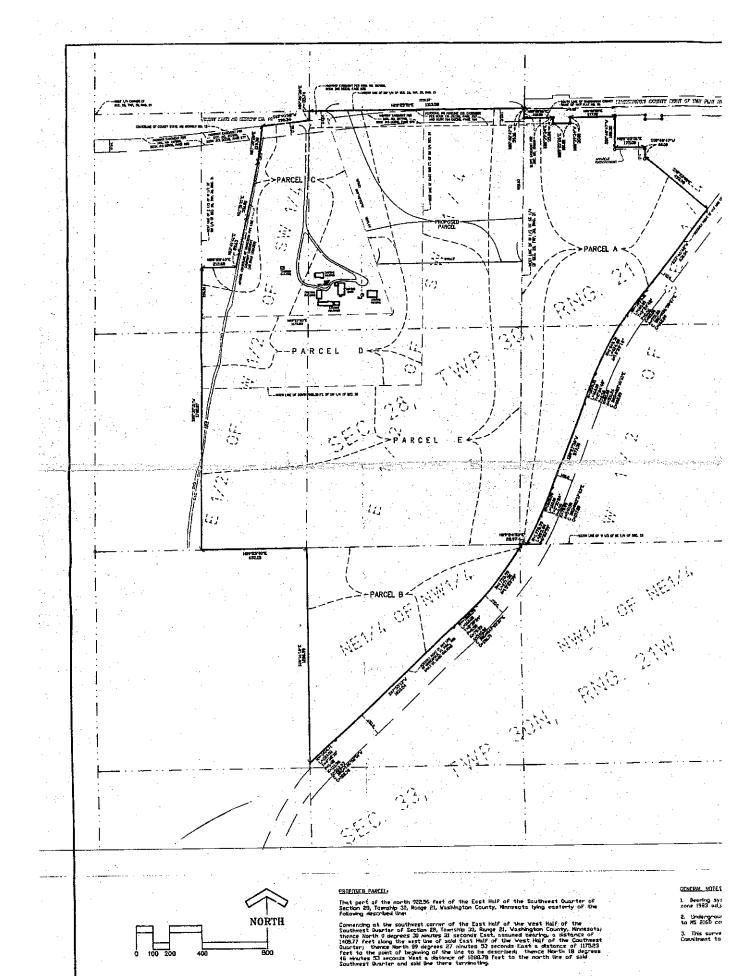

### **Feedlot Registration**

Water Quality/Feedlots 4.01 • Updated August 2009

innesota law requires most feedlots owners to register their feedlot with the Minnesota Pollution Control Agency (MPCA). Owners meet feedlot registration requirements by filling out a form that is provided by the MPCA. Owners that have applied for a permit are automatically registered.

Feedlot owners are required to update their registration information in every four-year interval after the initial registration deadline of January 1, 2002. The MPCA notifies owners 90 days prior to the re-registration deadline




The location and number of animals at the site determines whether or not a feedlot must register. Owners of the following operations must register:

- 1. Feedlots located in shoreland, and that maintain 10 animal units or more.
- 2. Feedlots located outside of shoreland, and that maintain 50 animal units or more.

Shoreland. Shoreland, in most instances, refers to land that is 1,000 feet or less from a lake or 300 feet or less from a river or stream. In rare instances, land near large ponds, wetlands or ditches is classified as shoreland.

Animal unit. An animal unit is a term used to compare the differences in the production of animal manure. The table below shows the typical number of animals

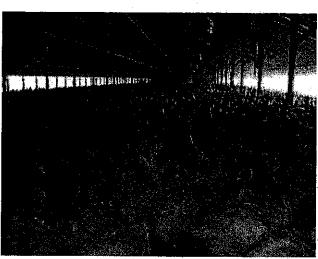

that it takes to exceed 10 animal units or 50 animals units:

Animal units	Dairy Cows	Beef Cows	Feeder Pigs
10	8	10	30
50	40	50	150

Owners that have closed their feedlots are not required to register. The MPCA defines a closed feedlot as a feedlot that has not had animals for the past five years.

#### **Pastures**

Livestock operations that are only pastures do not need to be registered. The definition of pastures in Minnesota Rule 7020 states that pastures are areas where grass or other growing plants are used for grazing and where the concentration of animals is such that a vegetation cover is maintained during the growing season except in the immediate vicinity of temporary supplemental feeding or watering devices.

MPCA Area Offices:

Rochester: 507/285-7343 Mankato: 507/389-5977 Marshall: 507/537-7146 Willmar: 320/214-3786 Detroit Lakes: 218/847-1519 Brainerd: 218/828-2492 Duluth: 218/723-4660 Metro:

651/296-6300

800/657-3864

Toll-Free Number:

wq-f4-01



### **Construction Short-Form Permit**

Water Quality/Feedlots #3.03 February 2001, Revised December 2005

Regional Division

Feedlot Program

The Construction Short-Form permit covers owners and operators of animal feedlots and manure storage areas having a capacity of 300 to 999 animals who are constructing or expanding their facility.

#### Do I Need a Construction Short-Form Permit?

To determine if a Construction Short-Form permit is appropriate for your facility, ask yourself the following four questions:

- 1. Do you intend to construct or expand a feedlot or manure storage area that is between 300 and 999 animal units?
- Will the feedlot or manure storage area be constructed and operated in accordance with the technical standards in Minn. Rule chapter 7020.2000 to 7020.2225?
- 3. Yes or no: the existing facility does **not** presently have a "pollution hazard"?
- 4. Yes or no: the capacity of the proposed facility will not meet or exceed the Large Concentrated Animal Feeding Operation threshold? (For information about this threshold see the factsheet "NPDES/SDS Feedlot Permits: Frequently Asked Questions" available on MPCA website.)

If you can answer "yes" to all four of the above questions, then the Construction Short-Form permit is appropriate for your situation.

Only construction that is in accordance with the technical standards of the feedlot rules, Minn. R. chap. 7020.2000 to

7020.2225, is covered under this permit. Owners who propose to construct or operate a facility in a method other than that described in the technical standards must apply for and obtain a State Disposal System (SDS) permit.

Sites under 300 animal units that are constructing or expanding and do not have a pollution hazard, do not need to apply for a permit, but do need to comply with the technical standards in the rule.

#### **Duration of the Permit**

Construction Short-Form permits expire after 24 months but may be extended for one 24-month period if construction has not been completed. This extension is to be requested at least 90 days prior to the expiration date of the permit.

#### For More Information

The content of the permit application is described under Minn. R. chap. 7020.0505 subp. 4. For a copy of the feedlot rule, contact the MPCA at 651-296-6300, 800-657-3864 or download it from the MPCA website:

http://www.pca.state.mn.us/hot/feedlot-forms.html.

Or, for more information call your area office listed on this fact sheet and ask for the feedlot staff person, or call your county feedlot officer.

507/285-7343 Mankato area: 507/389-5977 Marshall area: 507/537-7146 Willmar area: 320/214-3786 Detroit Lakes area: 218/847-1519 Brainerd area: 218/828-2492 Duluth area: 218/723-4660 Metro area: 651/296-6300 **Toll-Free Number:** 800/657-3864 Feedlot Service Center: 877/333-3508

MPCA Area Offices:

Rochester area:

Minnesota Pollution Control Agency, 520 Lafayette Road North, St. Paul, Minnesota 55155-4194 (612) 296-6300, toll-free (800) 657-3864, TDD (612) 282-5332

This material can be made available in alternative formats for people with disabilities.





Feedlot Program

Feedlot Rule Summary

#### **Contents**

**Permits** Construction notification Technical requirements Siting restrictions

See fact sheet, **Under 300 Animal Units: Operation and Management** for information about registration, manure application, pastures, stockpiles and other operational issues.

#### **MPCA Area Offices:**

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800/657-3864

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wq-f6-02

**Feedlot Service Center:** 

# **Under 300 Animal Units:** Construction and Expansion

February 2001

This fact sheet is intended to provide producers with the basic information they need to comply with the revised state feedlot regulations when constructing or expanding a feedlot. See MN Rule Chapter 7020 or referenced rules for specific information. Please keep in mind that where local ordinances are more restrictive than state laws, the local ordinance must also be followed. Please contact your local county feedlot officer or planning and zoning department.

#### **Permits**

No state feedlot permit is needed for construction, however, owners must comply with all technical standards for location, designs, construction and operation. Local permits and notifications may be required.

A State Disposal System (SDS) permit is needed for proposed construction that is different than technical standards under Chapter 7020.

#### **Construction Notifications**

The local zoning authority must be notified of all construction activities at least 30 days prior to construction.

Owners are required to notify the MPCA or delegated county at least three days prior to commencement of construction and within three days of completion of

construction. Construction notifications must be sent to MPCA or delegated county.

#### **Liquid Manure Storage Structures**

Standards for constructing liquid manure storage structures include:

- Seepage limits for various liner types
- Plans and specifications designed by an engineer
- Construction inspections
- Notifications and reports
- Location restrictions
- Separation to bedrock restrictions

A professional engineer or NRCS staff must prepare and sign plans and specifications (except concrete-lined structures having a capacity of less than 20,000 gallons).

#### **Location Restrictions**

New feedlots *cannot* be located:

- In shoreland
  - Within 300 feet of a river or stream
  - Within 1,000 feet of a lake, pond or flowage
- In a 100-year floodplain
- Within 300 feet of a sinkhole
- Within 100 feet of a private well

Minnesota Pollution Control Agency, 520 Lafayette Road North, St. Paul, Minnesota 55155-4194 (651) 296-6300, toll-free (800) 657-3864, TTY (651) 282-5332 or (800) 657-3864 This material can be made available in alternative formats for people with disabilities.

